
# MADISON PARK OUTPARCEL 2




C3.2

WAXHAW, NORTH CAROLINA

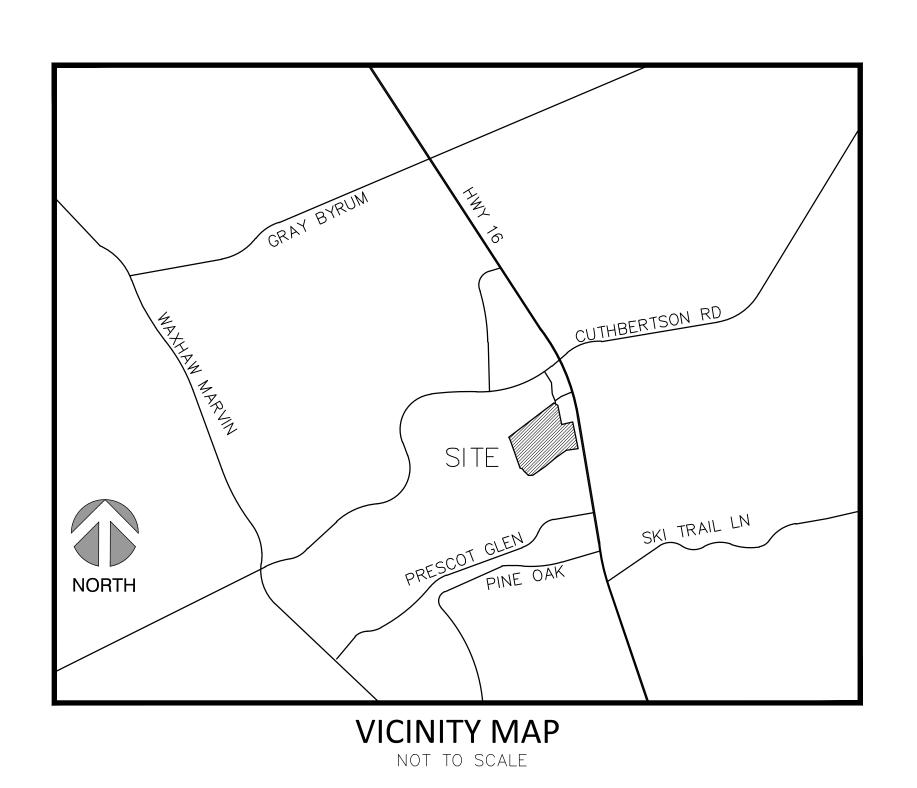

**605 LEXINGTON AVENUE, SUITE 301 CHARLOTTE, NC 28203** P) 704-749-1432 www.orsborn-eng.com

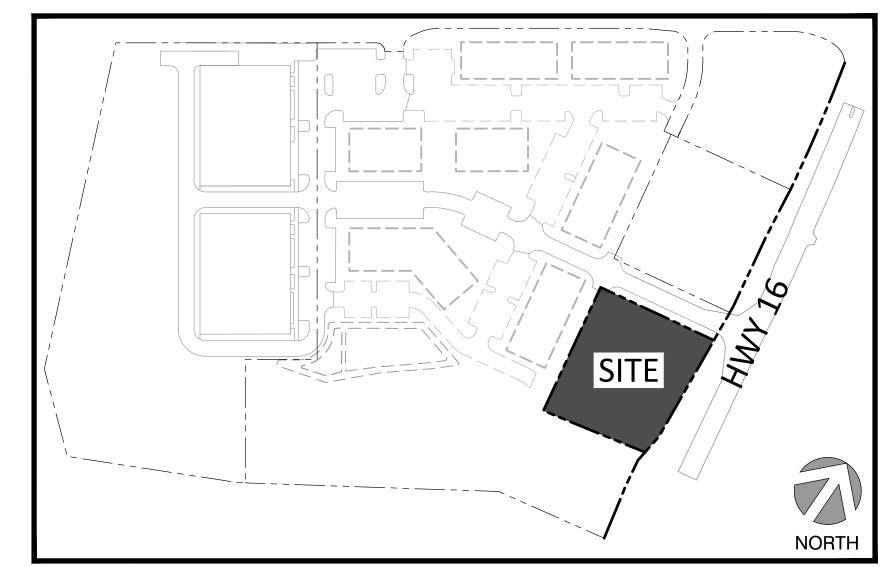


**MADISON PARK MAP** NOT TO SCALE


# SHEET INDEX

C2.1	SITE PLAN	C4.1	UTILITY PLAN
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C2.3	SITE DETAILS	C5.1	EROSION CONTROL PLAN
C2.4	TURNING MANEUVERS	L1.1	LANDSCAPE PLAN
C3.1	GRADING & DRAINAGE PLAN	L1.2	LANDSCAPE DETAILS


STORM PROFILES

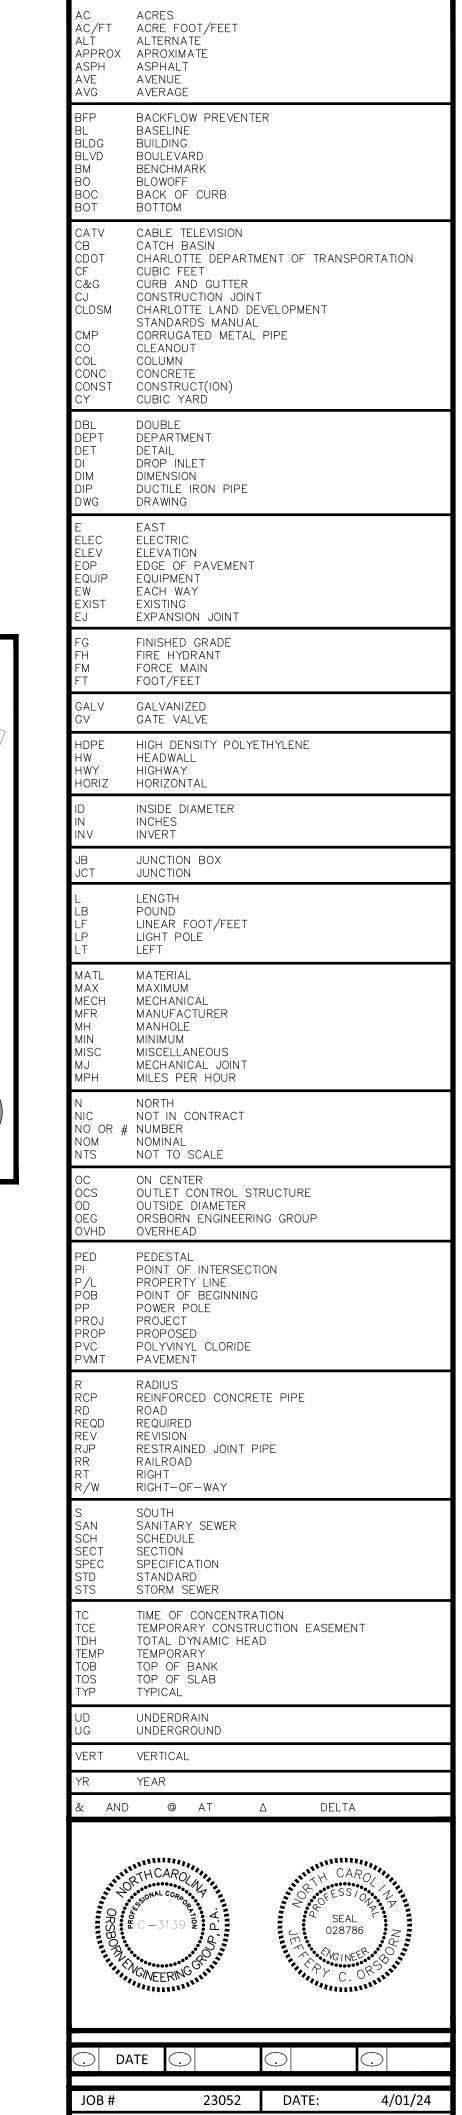


COVER

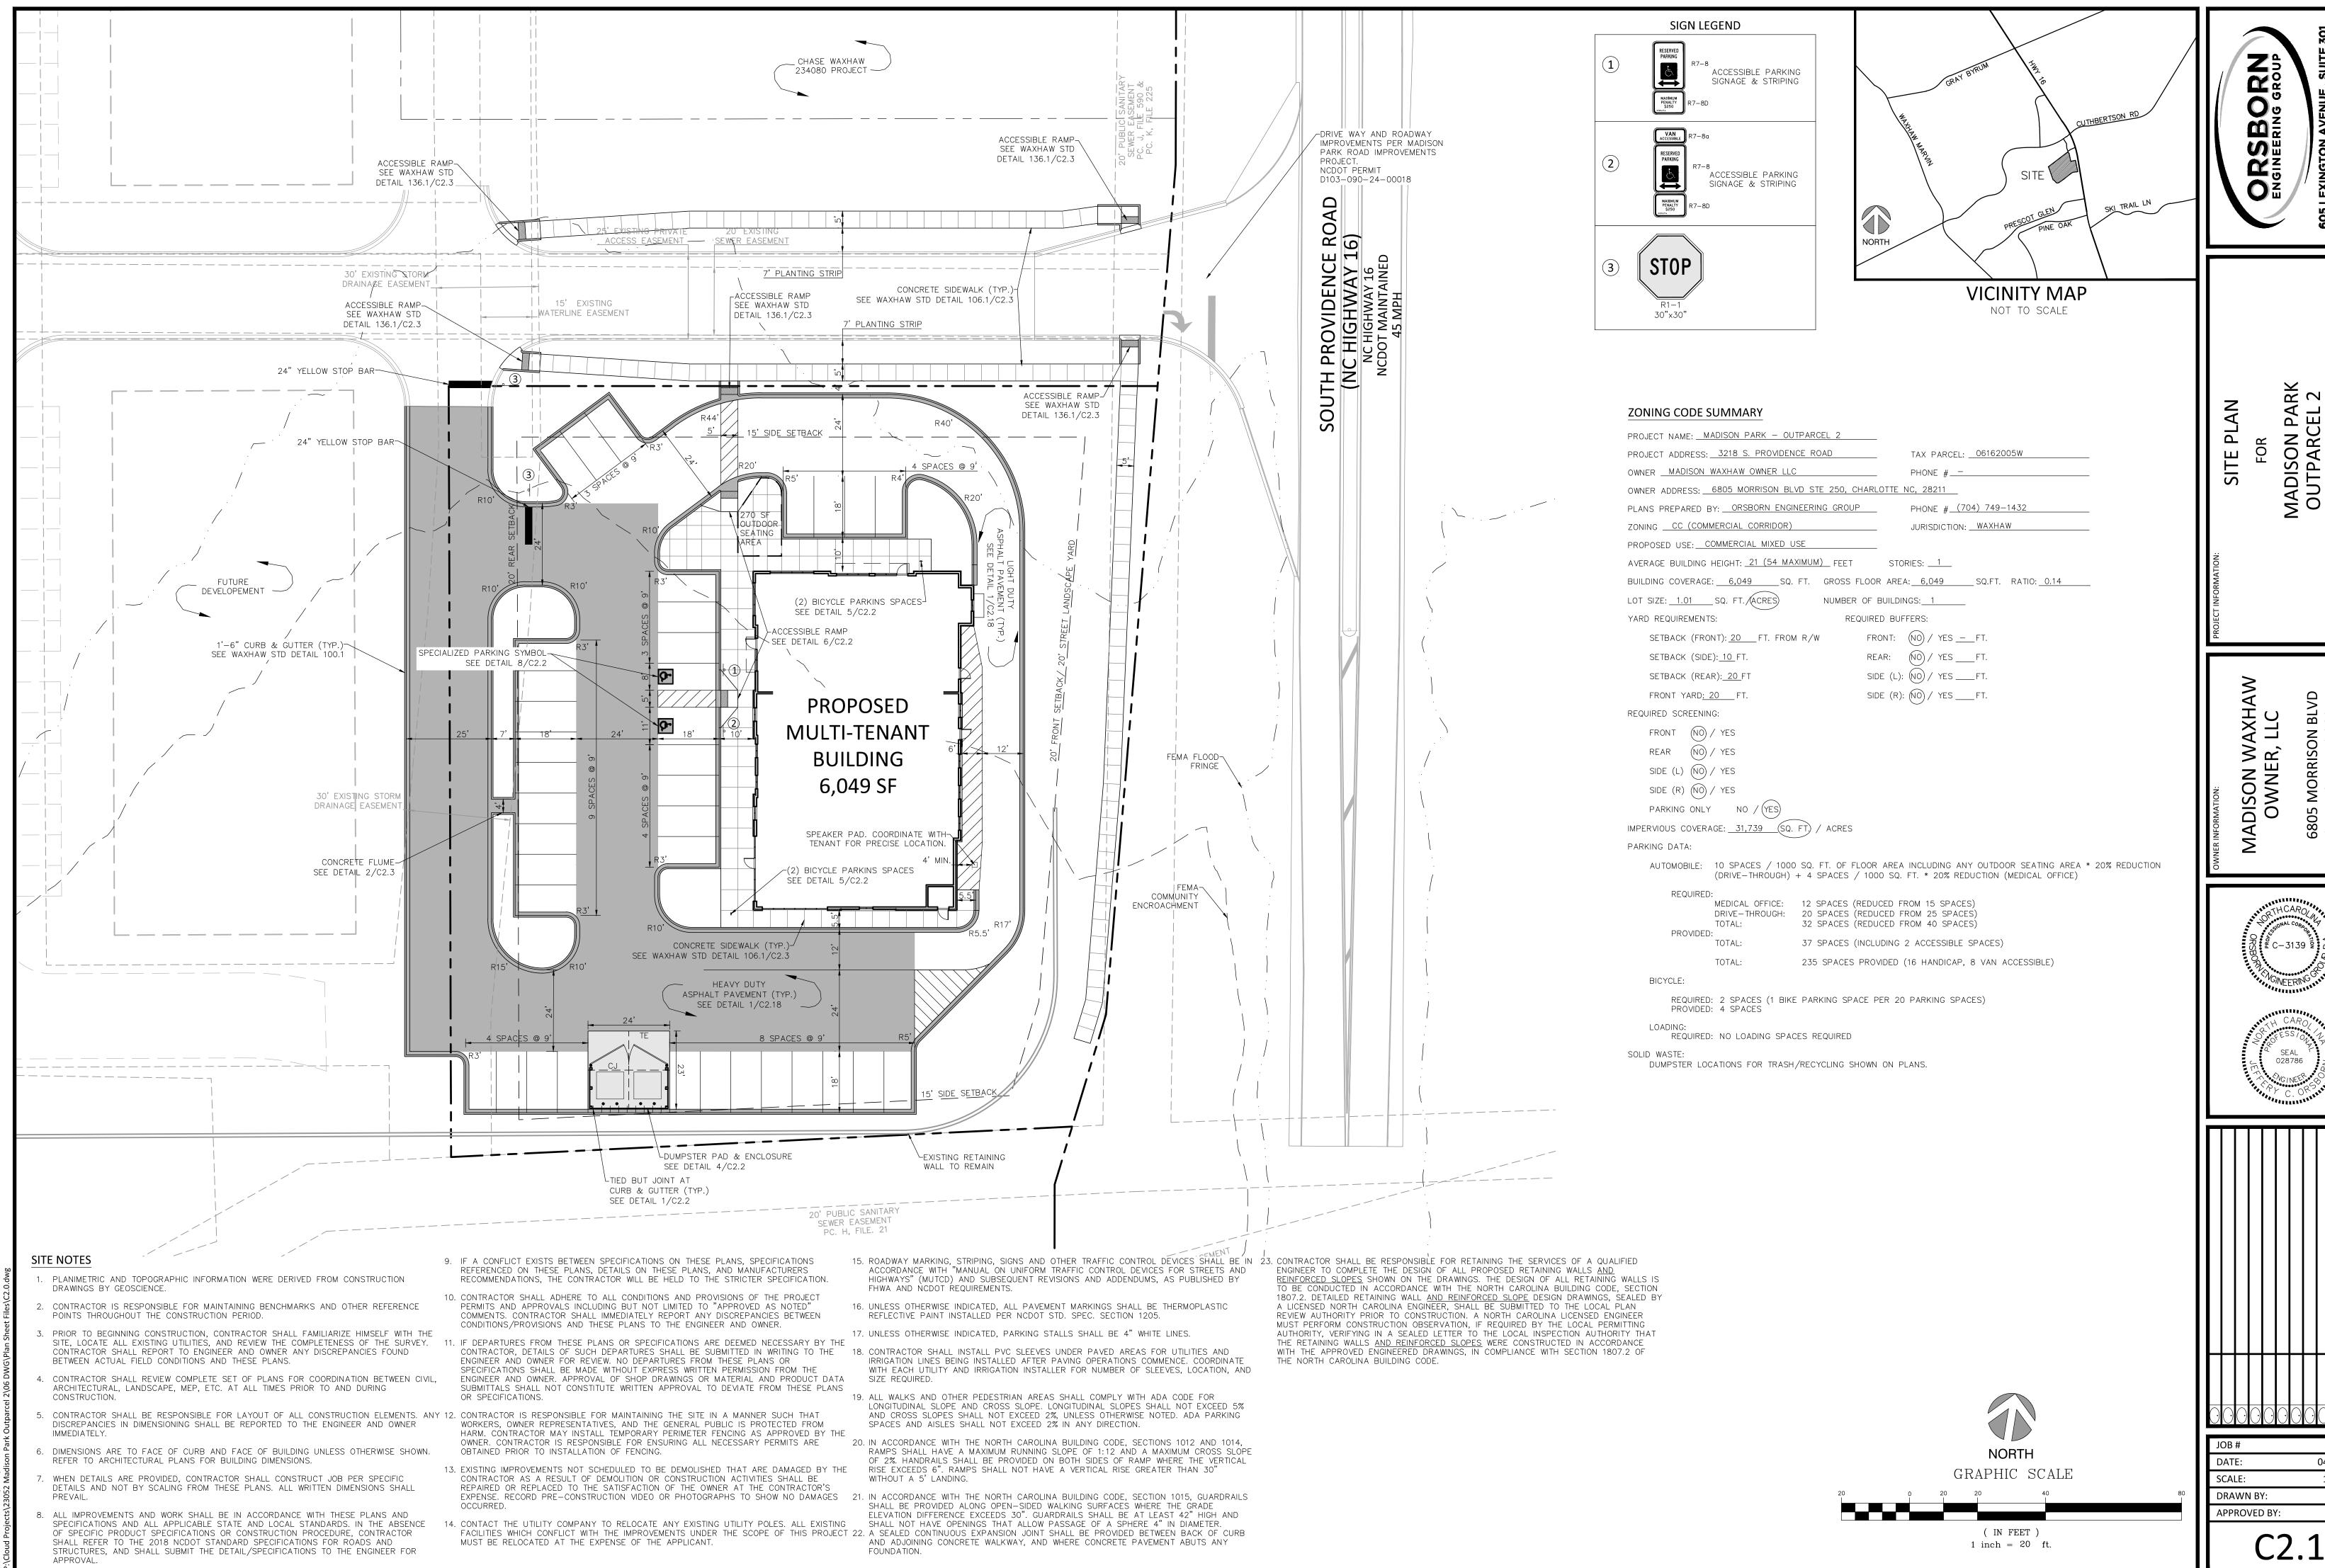


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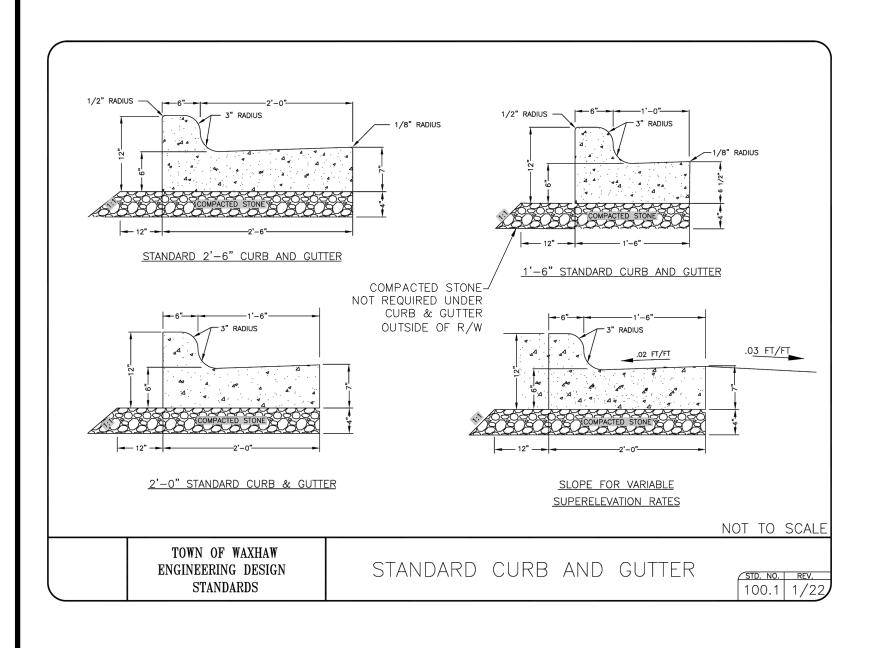


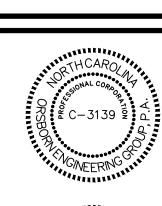


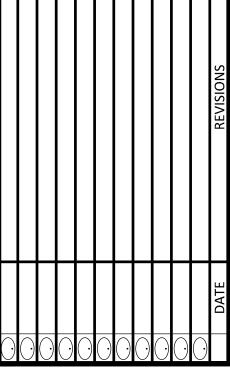



23052 04/01/24 1" = 20' DJS JCO




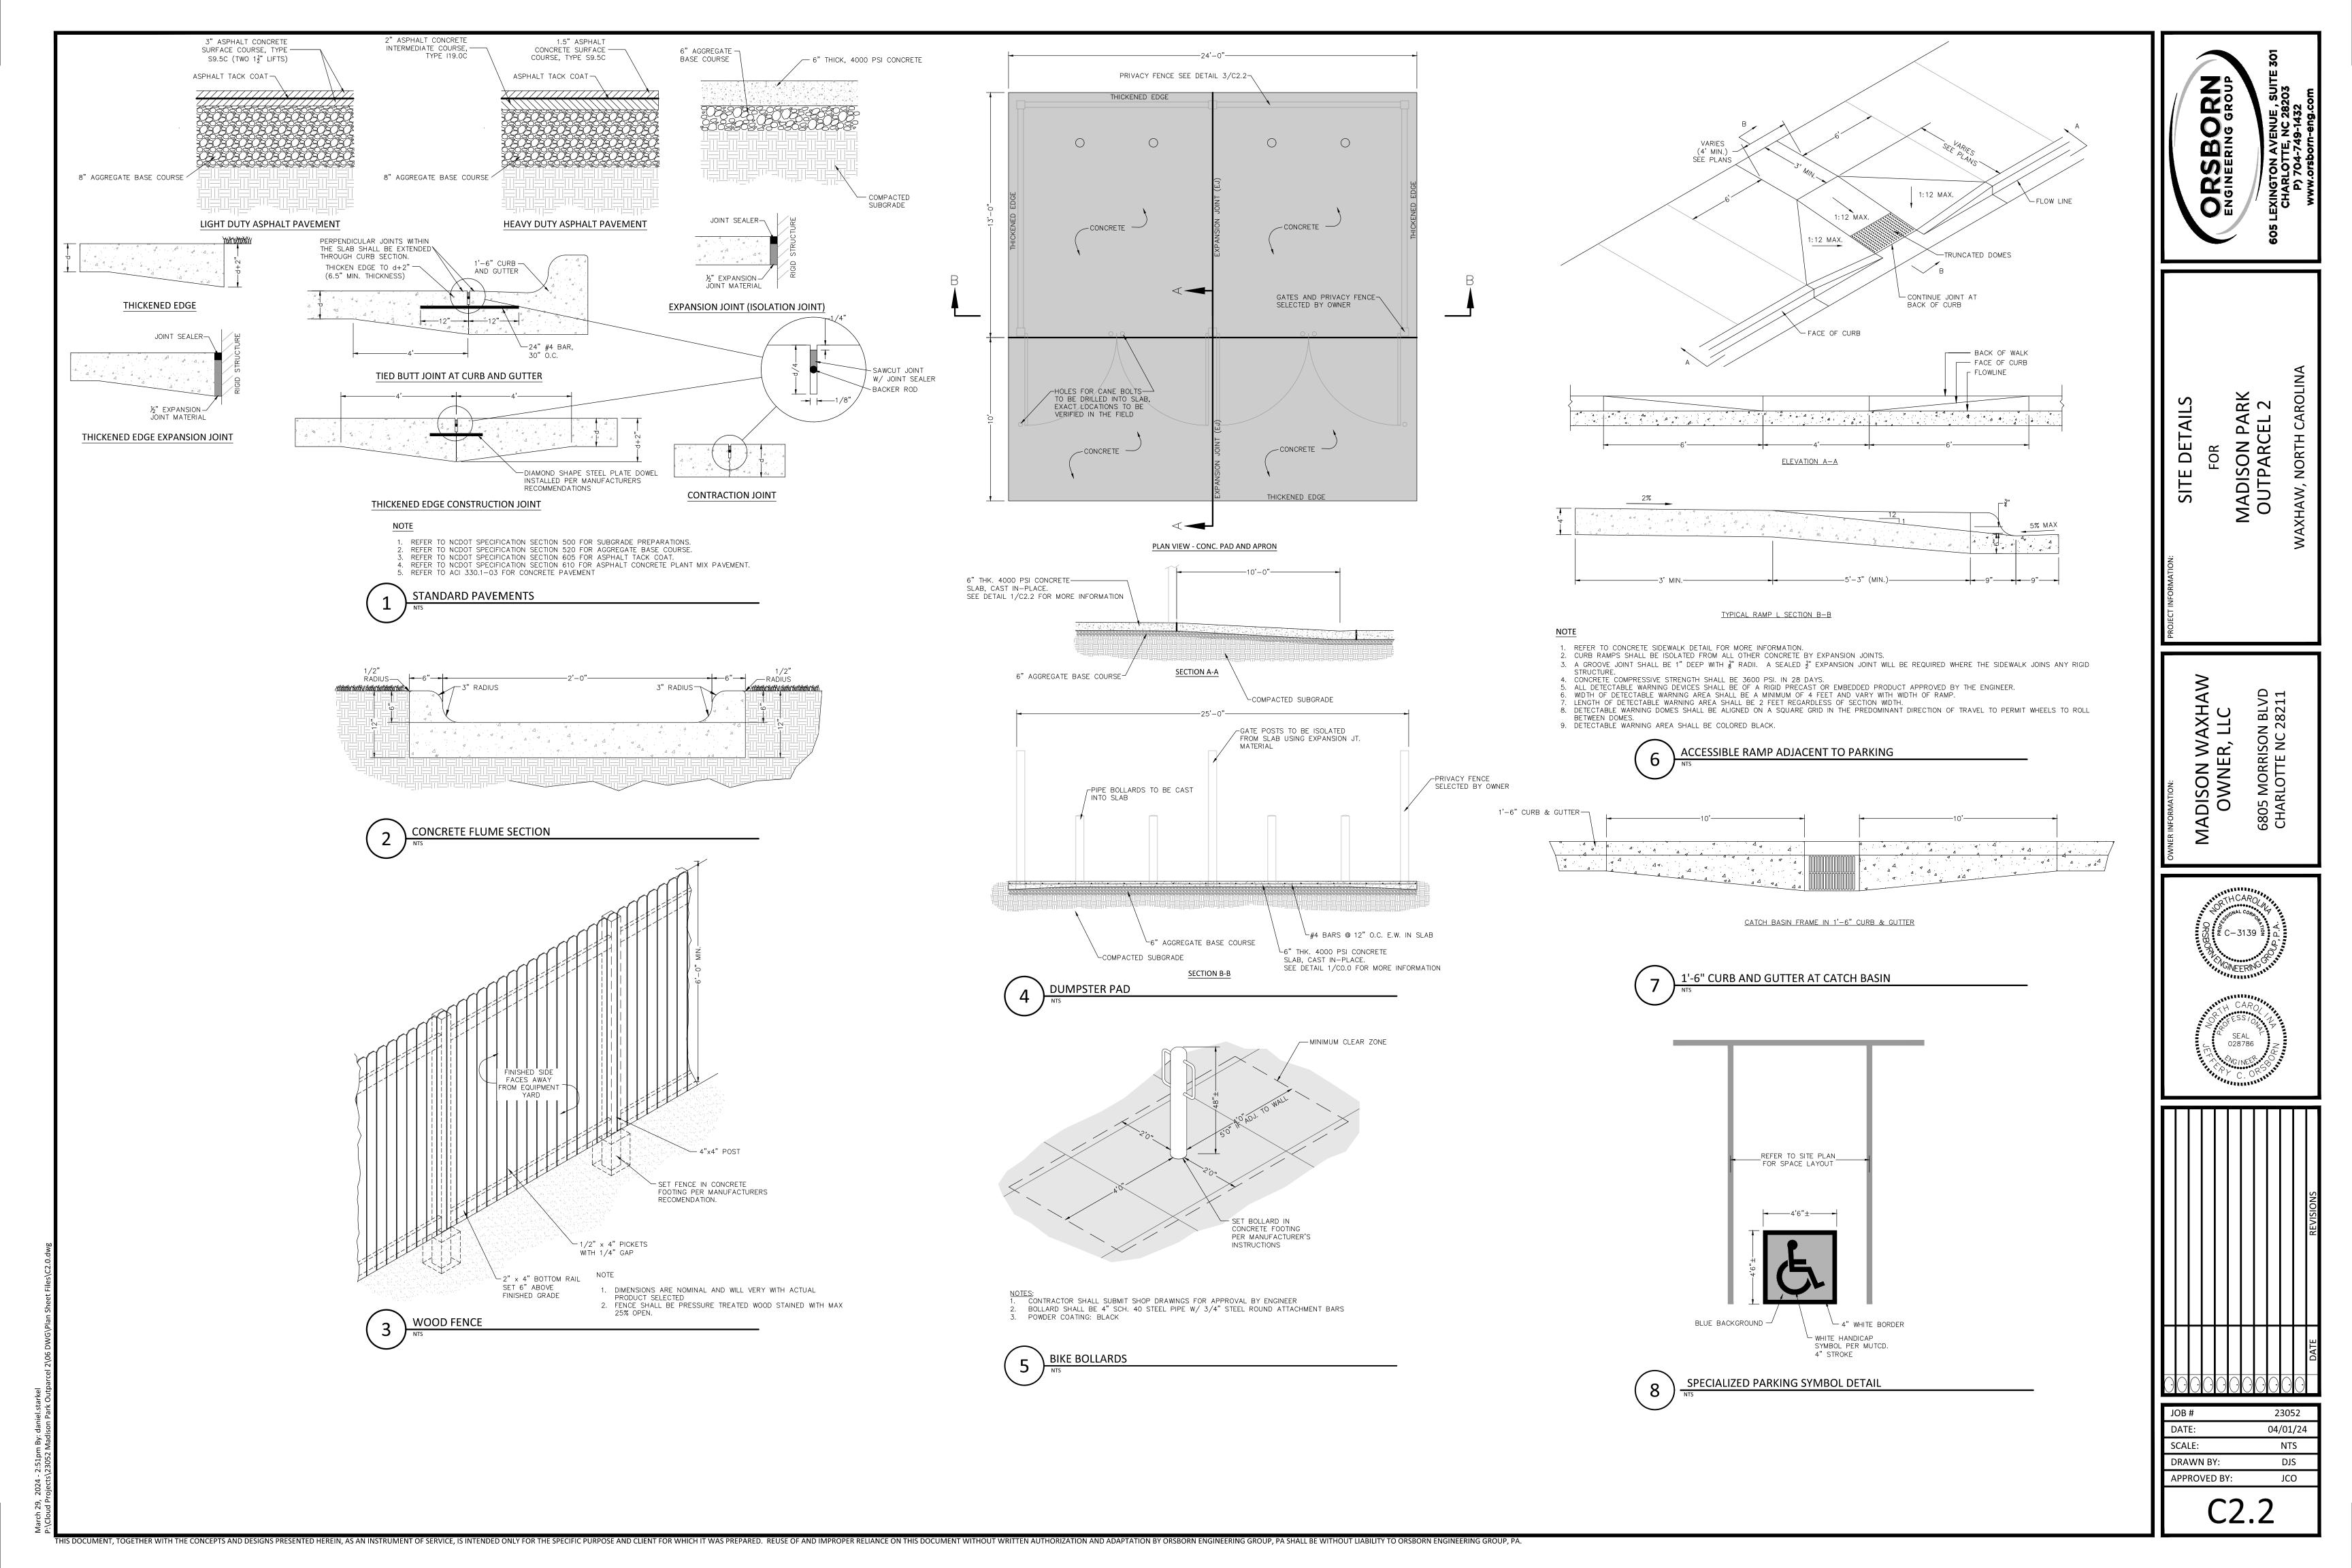


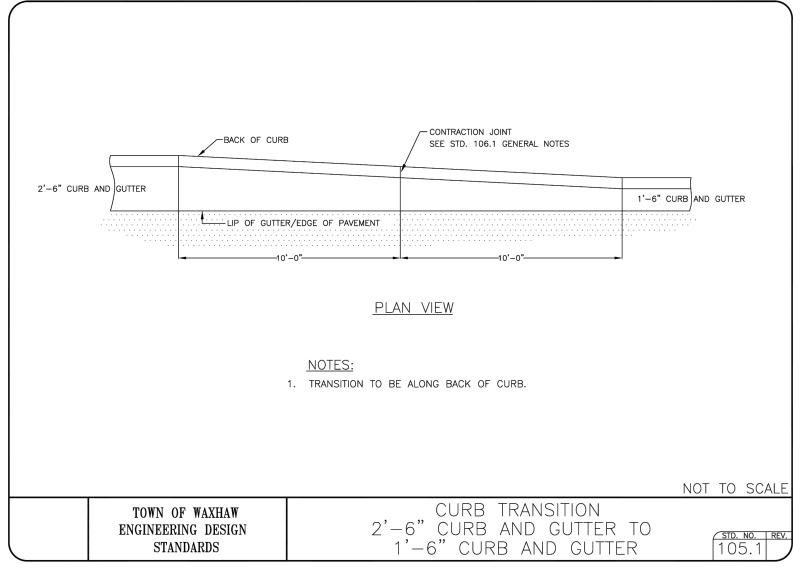


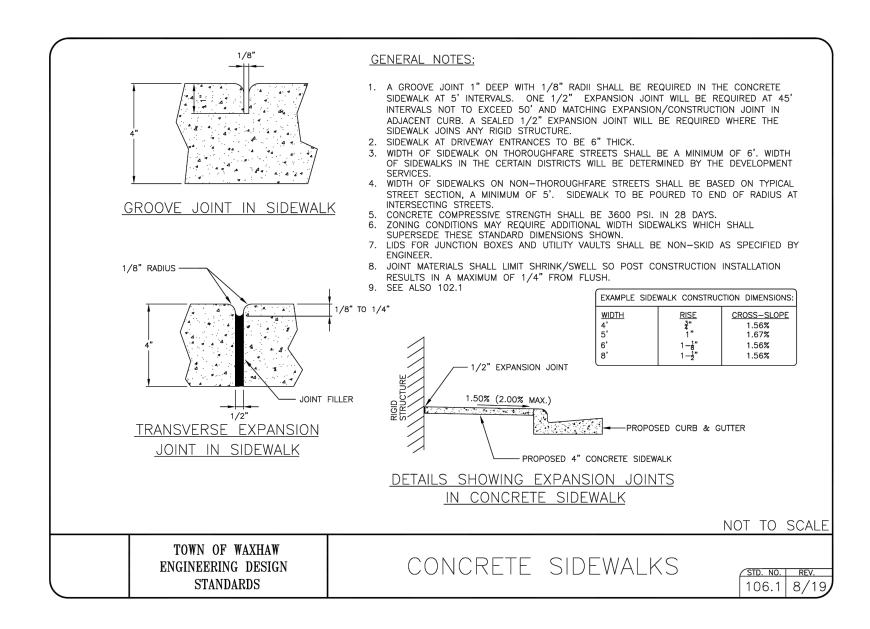


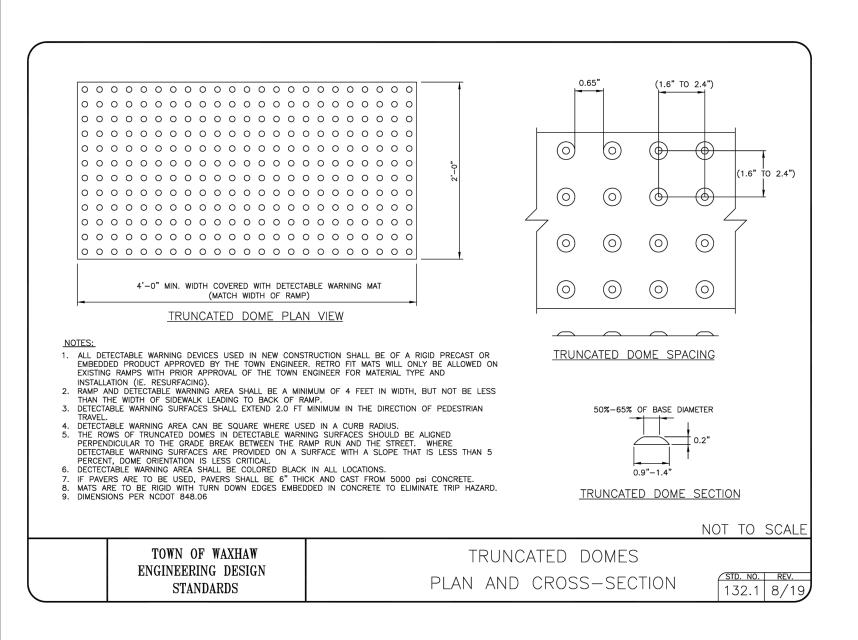

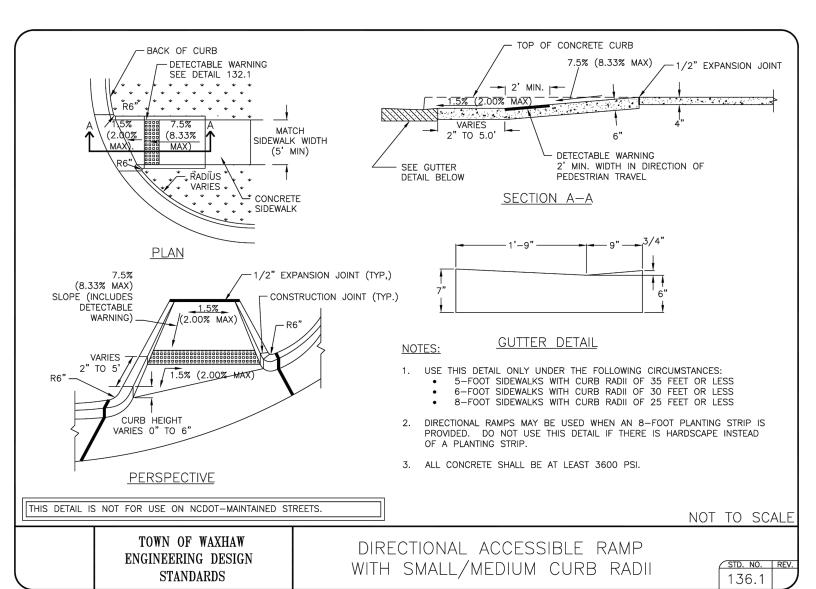

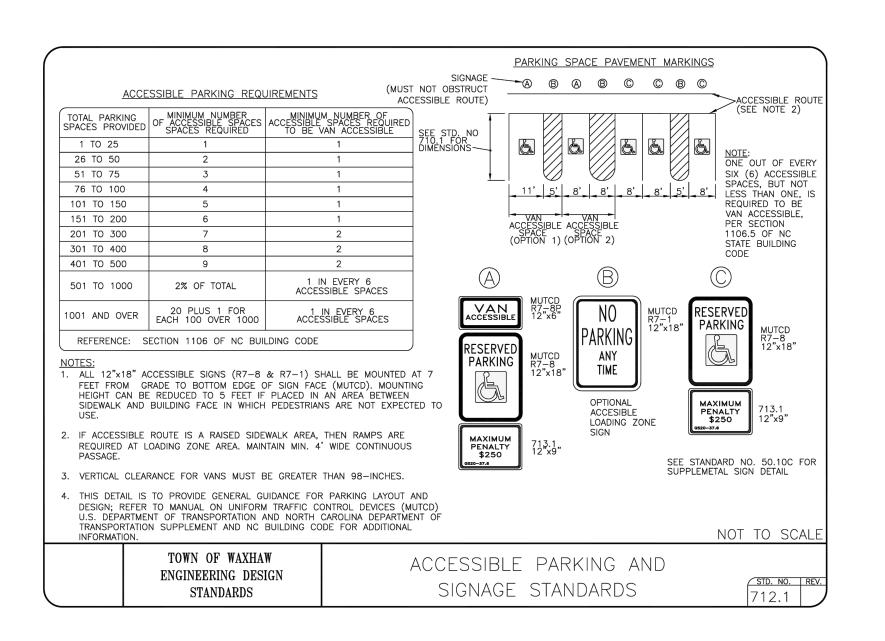

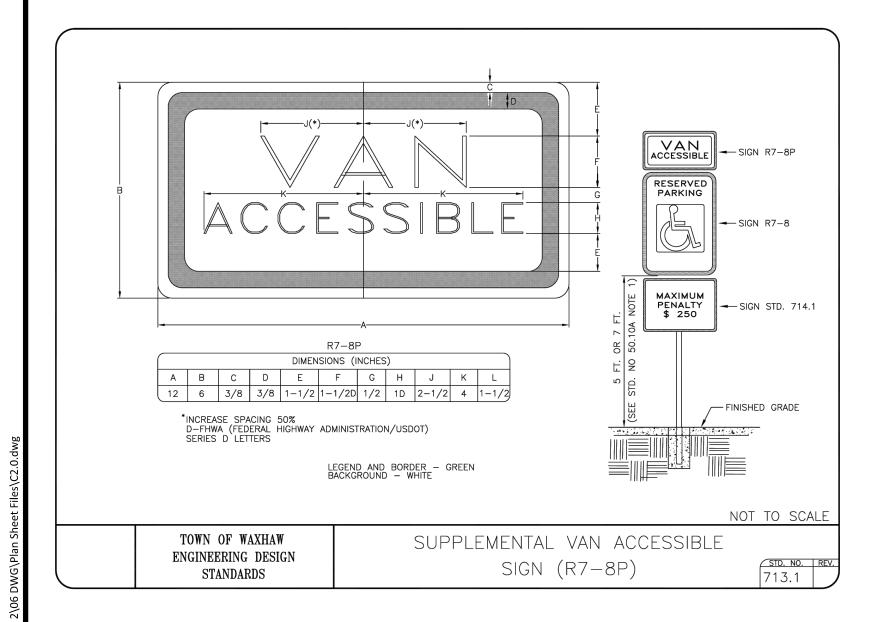

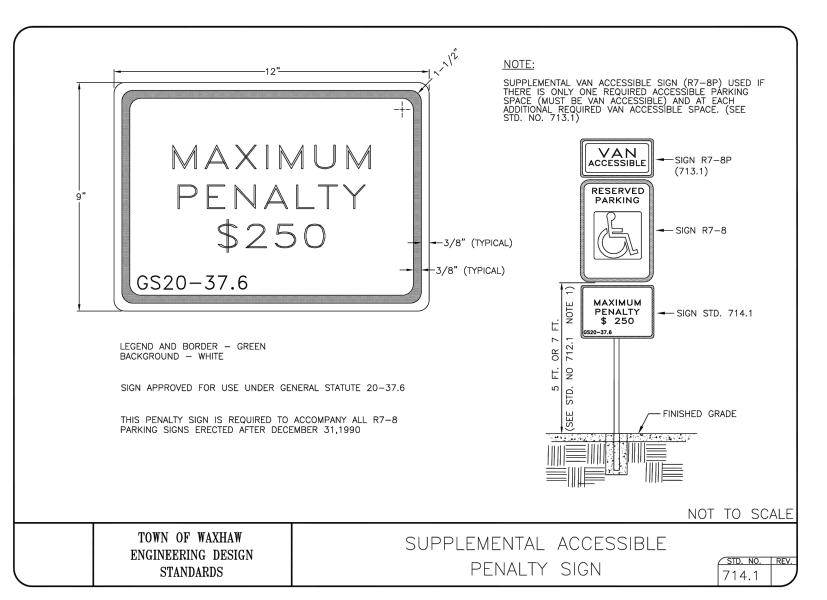

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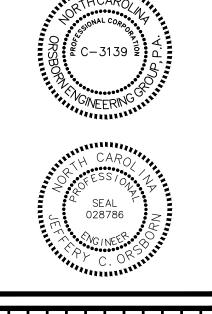



SITE DETIALS
FOR
MADISON PARK
OUTPARCEL 2

NORTH

MADISON WAXHAW OWNER, LLC


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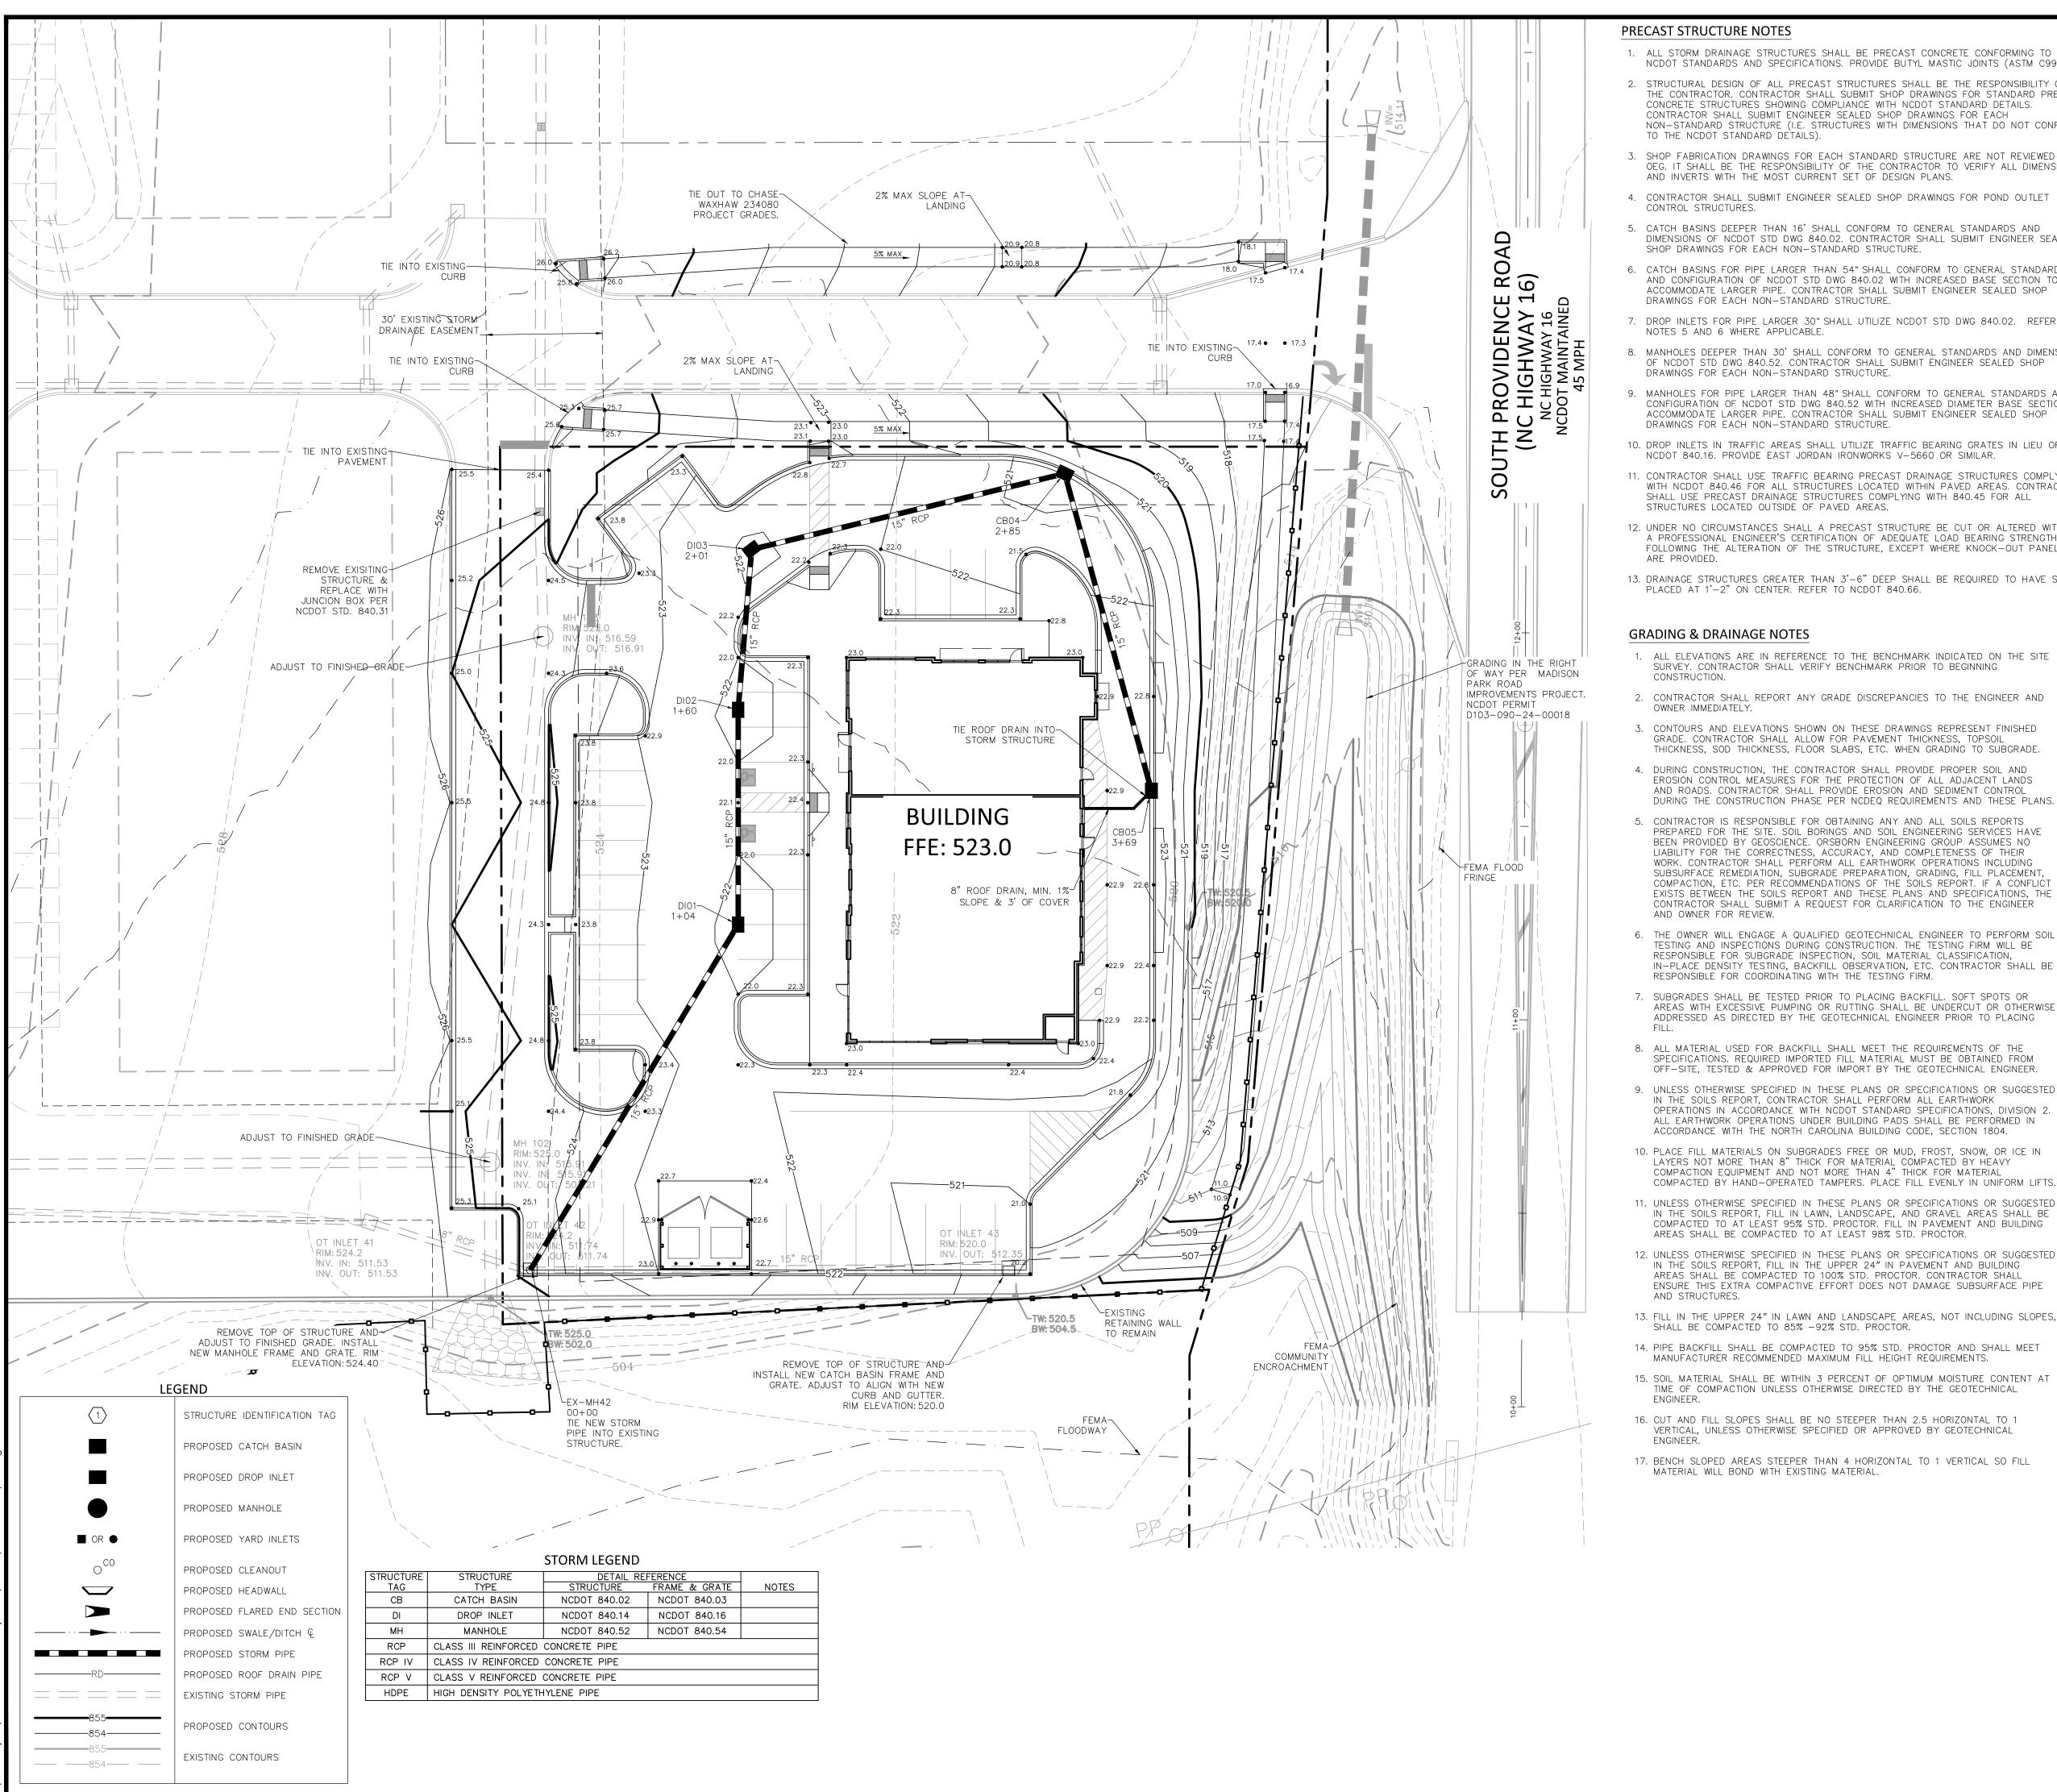


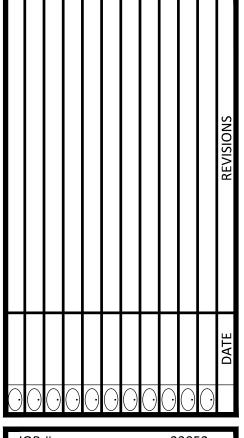

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APPROVED BY:	JCO
DRAWN BY:	DJS
SCALE:	NTS
DATE:	04/01/24
JOB #	23052

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- 1. ALL STORM DRAINAGE STRUCTURES SHALL BE PRECAST CONCRETE CONFORMING TO NCDOT STANDARDS AND SPECIFICATIONS. PROVIDE BUTYL MASTIC JOINTS (ASTM C990).
- 2. STRUCTURAL DESIGN OF ALL PRECAST STRUCTURES SHALL BE THE RESPONSIBILITY OF THE CONTRACTOR. CONTRACTOR SHALL SUBMIT SHOP DRAWINGS FOR STANDARD PRECAST CONCRETE STRUCTURES SHOWING COMPLIANCE WITH NCDOT STANDARD DETAILS. CONTRACTOR SHALL SUBMIT ENGINEER SEALED SHOP DRAWINGS FOR EACH NON-STANDARD STRUCTURE (I.E. STRUCTURES WITH DIMENSIONS THAT DO NOT CONFORM TO THE NCDOT STANDARD DETAILS).
- 3. SHOP FABRICATION DRAWINGS FOR EACH STANDARD STRUCTURE ARE NOT REVIEWED BY OEG. IT SHALL BE THE RESPONSIBILITY OF THE CONTRACTOR TO VERIFY ALL DIMENSIONS AND INVERTS WITH THE MOST CURRENT SET OF DESIGN PLANS.
- 4. CONTRACTOR SHALL SUBMIT ENGINEER SEALED SHOP DRAWINGS FOR POND OUTLET
- 5. CATCH BASINS DEEPER THAN 16' SHALL CONFORM TO GENERAL STANDARDS AND DIMENSIONS OF NCDOT STD DWG 840.02. CONTRACTOR SHALL SUBMIT ENGINEER SEALED SHOP DRAWINGS FOR EACH NON-STANDARD STRUCTURE.
- 6. CATCH BASINS FOR PIPE LARGER THAN 54" SHALL CONFORM TO GENERAL STANDARDS AND CONFIGURATION OF NCDOT STD DWG 840.02 WITH INCREASED BASE SECTION TO ACCOMMODATE LARGER PIPE. CONTRACTOR SHALL SUBMIT ENGINEER SEALED SHOP
- '. DROP INLETS FOR PIPE LARGER 30" SHALL UTILIZE NCDOT STD DWG 840.02. REFER TO NOTES 5 AND 6 WHERE APPLICABLE.
- . MANHOLES DEEPER THAN 30' SHALL CONFORM TO GENERAL STANDARDS AND DIMENSIONS OF NCDOT STD DWG 840.52. CONTRACTOR SHALL SUBMIT ENGINEER SEALED SHOP
- . MANHOLES FOR PIPE LARGER THAN 48" SHALL CONFORM TO GENERAL STANDARDS AND CONFIGURATION OF NCDOT STD DWG 840.52 WITH INCREASED DIAMETER BASE SECTION TO ACCOMMODATE LARGER PIPE. CONTRACTOR SHALL SUBMIT ENGINEER SEALED SHOP
- 10. DROP INLETS IN TRAFFIC AREAS SHALL UTILIZE TRAFFIC BEARING GRATES IN LIEU OF
- 11. CONTRACTOR SHALL USE TRAFFIC BEARING PRECAST DRAINAGE STRUCTURES COMPLYING WITH NCDOT 840.46 FOR ALL STRUCTURES LOCATED WITHIN PAVED AREAS. CONTRACTOR SHALL USE PRECAST DRAINAGE STRUCTURES COMPLYING WITH 840.45 FOR ALL STRUCTURES LOCATED OUTSIDE OF PAVED AREAS.
- 12. UNDER NO CIRCUMSTANCES SHALL A PRECAST STRUCTURE BE CUT OR ALTERED WITHOUT A PROFESSIONAL ENGINEER'S CERTIFICATION OF ADEQUATE LOAD BEARING STRENGTH FOLLOWING THE ALTERATION OF THE STRUCTURE, EXCEPT WHERE KNOCK-OUT PANELS
- 13. DRAINAGE STRUCTURES GREATER THAN 3'-6" DEEP SHALL BE REQUIRED TO HAVE STEPS PLACED AT 1'-2" ON CENTER. REFER TO NCDOT 840.66.

#### **GRADING & DRAINAGE NOTES**

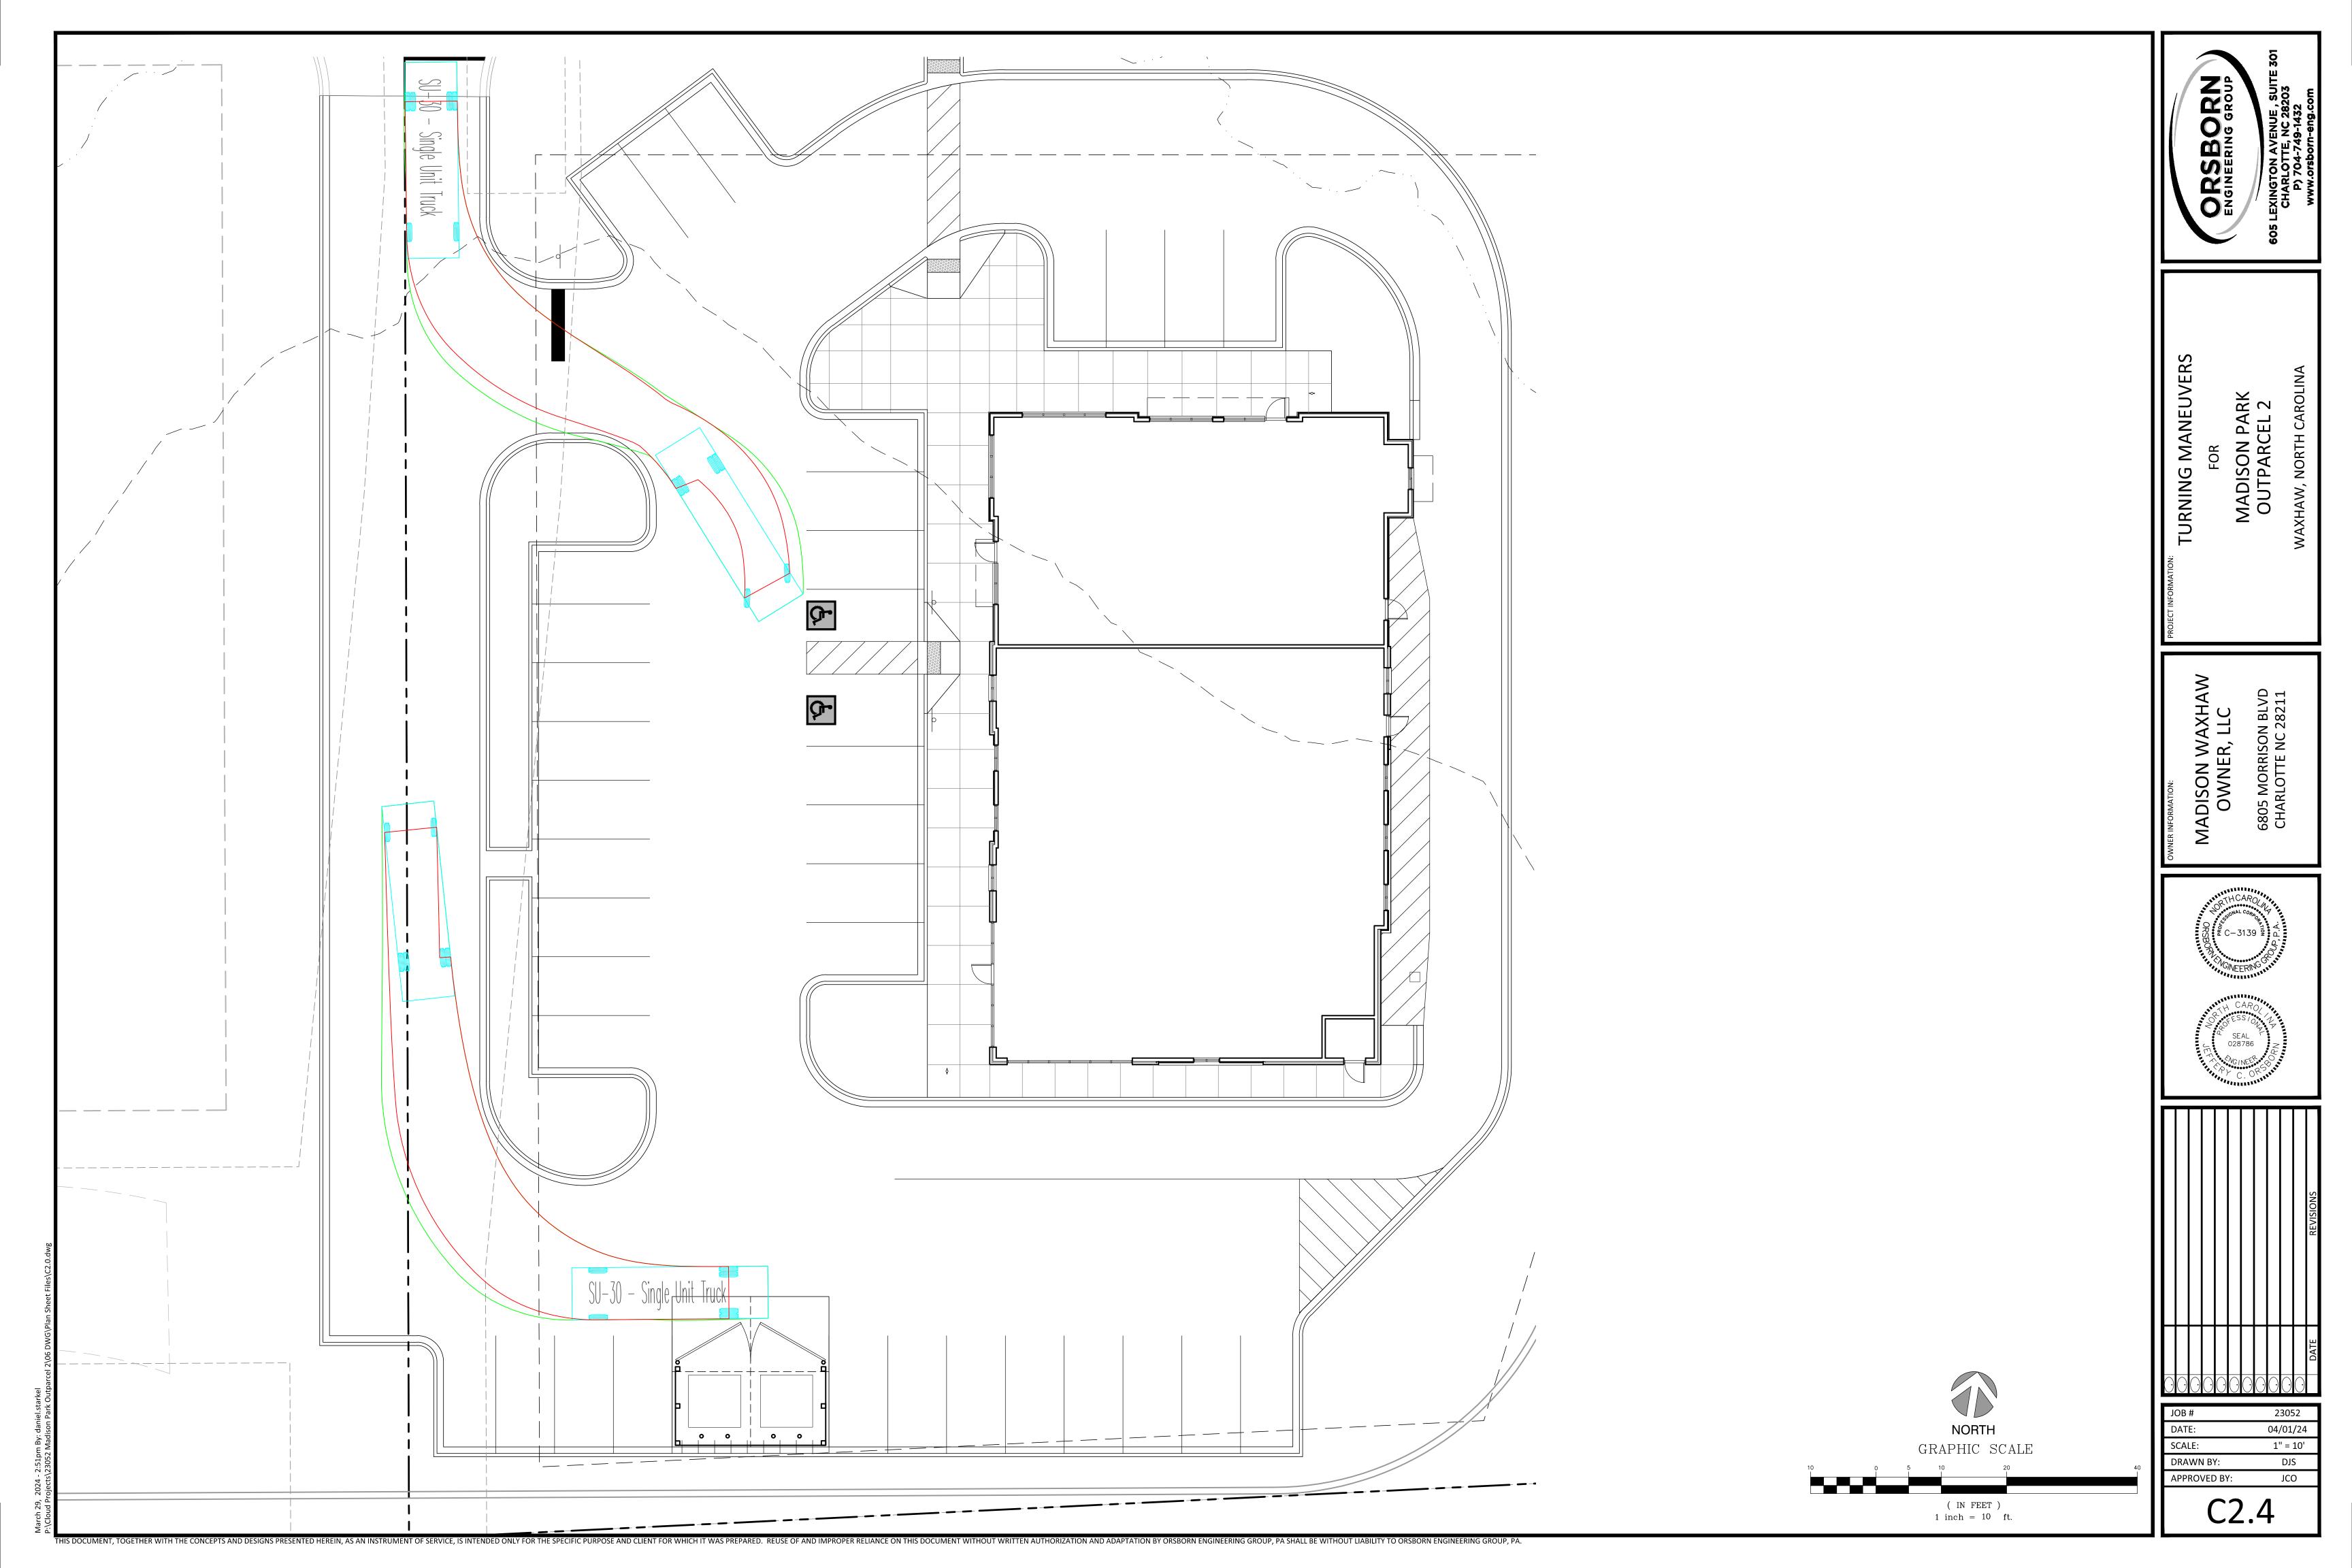- 1. ALL ELEVATIONS ARE IN REFERENCE TO THE BENCHMARK INDICATED ON THE SITE SURVEY. CONTRACTOR SHALL VERIFY BENCHMARK PRIOR TO BEGINNING
- 2. CONTRACTOR SHALL REPORT ANY GRADE DISCREPANCIES TO THE ENGINEER AND
- 3. CONTOURS AND ELEVATIONS SHOWN ON THESE DRAWINGS REPRESENT FINISHED GRADE. CONTRACTOR SHALL ALLOW FOR PAVEMENT THICKNESS, TOPSOIL THICKNESS, SOD THICKNESS, FLOOR SLABS, ETC. WHEN GRADING TO SUBGRADE.
- 4. DURING CONSTRUCTION, THE CONTRACTOR SHALL PROVIDE PROPER SOIL AND EROSION CONTROL MEASURES FOR THE PROTECTION OF ALL ADJACENT LANDS AND ROADS. CONTRACTOR SHALL PROVIDE EROSION AND SEDIMENT CONTROL DURING THE CONSTRUCTION PHASE PER NCDEQ REQUIREMENTS AND THESE PLANS.
- 5. CONTRACTOR IS RESPONSIBLE FOR OBTAINING ANY AND ALL SOILS REPORTS PREPARED FOR THE SITE. SOIL BORINGS AND SOIL ENGINEERING SERVICES HAVE BEEN PROVIDED BY GEOSCIENCE. ORSBORN ENGINEERING GROUP ASSUMES NO LIABILITY FOR THE CORRECTNESS, ACCURACY, AND COMPLETENESS OF THEIR WORK. CONTRACTOR SHALL PERFORM ALL EARTHWORK OPERATIONS INCLUDING SUBSURFACE REMEDIATION, SUBGRADE PREPARATION, GRADING, FILL PLACEMENT, COMPACTION, ETC. PER RECOMMENDATIONS OF THE SOILS REPORT. IF A CONFLICT EXISTS BETWEEN THE SOILS REPORT AND THESE PLANS AND SPECIFICATIONS, THE CONTRACTOR SHALL SUBMIT A REQUEST FOR CLARIFICATION TO THE ENGINEER
- 6. THE OWNER WILL ENGAGE A QUALIFIED GEOTECHNICAL ENGINEER TO PERFORM SOIL 25. ALL CATCH BASINS, MANHOLES, DROP INLETS, VALUE BOXES, ETC. RESPONSIBLE FOR SUBGRADE INSPECTION, SOIL MATERIAL CLASSIFICATION, IN-PLACE DENSITY TESTING, BACKFILL OBSERVATION, ETC. CONTRACTOR SHALL BE RESPONSIBLE FOR COORDINATING WITH THE TESTING FIRM.
- 7. SUBGRADES SHALL BE TESTED PRIOR TO PLACING BACKFILL. SOFT SPOTS OR AREAS WITH EXCESSIVE PUMPING OR RUTTING SHALL BE UNDERCUT OR OTHERWISE BOXES SHALL BE COMPLETED IN ACCORDANCE WITH NCDOT STANDARD ADDRESSED AS DIRECTED BY THE GEOTECHNICAL ENGINEER PRIOR TO PLACING
- 8. ALL MATERIAL USED FOR BACKFILL SHALL MEET THE REQUIREMENTS OF THE SPECIFICATIONS. REQUIRED IMPORTED FILL MATERIAL MUST BE OBTAINED FROM OFF-SITE, TESTED & APPROVED FOR IMPORT BY THE GEOTECHNICAL ENGINEER.
- 9. UNLESS OTHERWISE SPECIFIED IN THESE PLANS OR SPECIFICATIONS OR SUGGESTED IN THE SOILS REPORT, CONTRACTOR SHALL PERFORM ALL EARTHWORK OPERATIONS IN ACCORDANCE WITH NCDOT STANDARD SPECIFICATIONS, DIVISION 2. ALL EARTHWORK OPERATIONS UNDER BUILDING PADS SHALL BE PERFORMED IN ACCORDANCE WITH THE NORTH CAROLINA BUILDING CODE, SECTION 1804.
- 10. PLACE FILL MATERIALS ON SUBGRADES FREE OR MUD, FROST, SNOW, OR ICE IN LAYERS NOT MORE THAN 8" THICK FOR MATERIAL COMPACTED BY HEAVY COMPACTION EQUIPMENT AND NOT MORE THAN 4" THICK FOR MATERIAL COMPACTED BY HAND-OPERATED TAMPERS. PLACE FILL EVENLY IN UNIFORM LIFTS.
- 11. UNLESS OTHERWISE SPECIFIED IN THESE PLANS OR SPECIFICATIONS OR SUGGESTED IN THE SOILS REPORT, FILL IN LAWN, LANDSCAPE, AND GRAVEL AREAS SHALL BE 30. IF REQUIRED BY THE LOCAL JURISDICTION, CONTRACTOR SHALL PROVIDE THE COMPACTED TO AT LEAST 95% STD. PROCTOR. FILL IN PAVEMENT AND BUILDING AREAS SHALL BE COMPACTED TO AT LEAST 98% STD. PROCTOR.
- AREAS SHALL BE COMPACTED TO 100% STD. PROCTOR. CONTRACTOR SHALL ENSURE THIS EXTRA COMPACTIVE EFFORT DOES NOT DAMAGE SUBSURFACE PIPE
- 13. FILL IN THE UPPER 24" IN LAWN AND LANDSCAPE AREAS, NOT INCLUDING SLOPES, SHALL BE COMPACTED TO 85% -92% STD. PROCTOR.
- 14. PIPE BACKFILL SHALL BE COMPACTED TO 95% STD. PROCTOR AND SHALL MEET MANUFACTURER RECOMMENDED MAXIMUM FILL HEIGHT REQUIREMENTS.
- 15. SOIL MATERIAL SHALL BE WITHIN 3 PERCENT OF OPTIMUM MOISTURE CONTENT AT TIME OF COMPACTION UNLESS OTHERWISE DIRECTED BY THE GEOTECHNICAL
- 16. CUT AND FILL SLOPES SHALL BE NO STEEPER THAN 2.5 HORIZONTAL TO 1 VERTICAL, UNLESS OTHERWISE SPECIFIED OR APPROVED BY GEOTECHNICAL
- 17. BENCH SLOPED AREAS STEEPER THAN 4 HORIZONTAL TO 1 VERTICAL SO FILL MATERIAL WILL BOND WITH EXISTING MATERIAL.

18. CONTRACTOR SHALL BLEND NEW EARTHWORK TO PROVIDE A SMOOTH TRANSITION

**VICINITY MAP** 

NOT TO SCALE

- 19. GRADES IMMEDIATELY ADJACENT TO BUILDING FOUNDATIONS SHALL SLOPE AWAY AT A SLOPE NOT LESS THAN 5% FOR A MINIMUM DISTANCE OF 10 FEET. IMPERVIOUS SURFACES SHALL SLOPE AWAY AT A SLOPE OF 2%, UNLESS
- 20. INTERIM GRADING SHALL BE PROVIDED TO DIRECT WATER AWAY FROM BUILDINGS AND PROTECT ALL STRUCTURES, UTILITIES, PAVEMENT, ETC. FROM UNDERMINING, WASHOUT, OR MOVEMENT.
- 21. PORTIONS OF THIS PROJECT MAY REQUIRE SLOPES ACROSS PAVED AREAS AND LAWNS LESS THAN 2%. CONTRACTOR SHALL TAKE CARE IN THESE AREAS TO PROVIDE POSITIVE DRAINAGE TO ENSURE RUNOFF SHEETS ACROSS NEW PAVEMENT OR LAWN AREAS TO PROPOSED OR EXISTING STORM INLETS.
- 22. ROOF DRAIN / DOWNSPOUT COLLECTION SYSTEMS SHALL BE PVC (SCH. 40) OR HDPE (TYPE S) INSTALLED AT 1% MINIMUM AND WITH 2' MINIMUM COVER, UNLESS OTHERWISE NOTED. TIE INTO STORM DRAINAGE SYSTEMS GENERALLY AS SHOWN ON
- 23. ALL STORM DRAINAGE PIPE (RCP, HDPE, ETC.) SHALL CONFORM TO NCDOT STD. SPEC. SECTION 1032. PIPE SHALL BE INSTALLED PER NCDOT STD. SPEC. SECTION
- 24. PIPE LENGTHS ARE MEASURED FROM CENTER OF STRUCTURE TO CENTER OF STRUCTURE.
- STANDARD SPECIFICATIONS, SECTION 858. ALTERED STRUCTURES SHALL MEET THE REQUIREMENTS OF A NEW STRUCTURE IN REGARDS TO STEP PLACEMENT, NUMBER OF GRADE RINGS, ETC.
- 26. ALL CATCH BASINS AND DROP INLETS REQUIRING CONVERSION TO JUNCTION SPECIFICATIONS, SECTION 859.
- 27. PRIOR TO COMMENCING STORM SEWER INSTALLATION, CONTRACTOR SHALL VERIFY SIZE OF EACH EXISTING STORM STRUCTURE REQUIRED TO BE MODIFIED TO ACCEPT A NEW PIPE. STRUCTURES NOT ADEQUATELY SIZED FOR NEW PIPE SHALL BE REPLACED OR MODIFIED, REUSING PORTIONS OF THE EXISTING STRUCTURE WHEREVER POSSIBLE.
- 28. CONTRACTOR SHALL PROVIDE STORM DRAINAGE AS-BUILT DRAWINGS (CAD & PDF) PREPARED AND SEALED BY A NORTH CAROLINA PROFESSIONAL LAND SURVEYOR. AS-BUILT DATA SHALL INCLUDE STRUCTURE RIM ELEVATIONS AND HORIZONTAL PIPE LENGTHS, BEARINGS, INVERTS, SLOPES, PIPE SIZES, AND PIPE MATERIALS, A
- 29. CONTRACTOR SHALL BE RESPONSIBLE FOR ENSURING THAT ALL NEWLY CONSTRUCTED STORM DRAINAGE IMPROVEMENTS AND RECEIVING STORM DRAINAGE SYSTEMS ARE CLEAN OF SEDIMENT ACCUMULATION AND DEBRIS. FLUSH SYSTEMS
- OWNER WITH A VIDEO INSPECTION OF THE STORM SEWER SYSTEM. THIS VIDEO MAY NEED TO BE REVIEWED AND ACCEPTED BY THE LOCAL JURISDICTION PRIOR TO
- 31. ORSBORN ENGINEERING GROUP HAS NOT REVIEWED THE STRUCTURAL STABILITY OF ANY EXISTING RETAINING WALLS NOTED TO REMAIN.

ISSUANCE OF A FINAL BUILDING CERTIFICATE OF OCCUPANCY.

AS NECESSARY PRIOR TO OWNER ACCEPTANCE.

- 32. ALL DISTURBED AREAS BEYOND THE LIMITS OF PAVEMENT AND BUILDING NOT IMPROVED WITH LANDSCAPE BEDS PER THE LANDSCAPE PLANS SHALL BE IMPROVED WITH A NEW LAWN SEEDED OR SODDED AS DIRECTED BY OWNER. CONTRACTOR SHALL MAINTAIN NEW SEEDED LAWN AREAS UNTIL A HEALTHY STAND OF GRASS IS ESTABLISHED.
- 33. THE CONTRACTOR SHALL BE RESPONSIBLE FOR THE MAINTENANCE OF ALL LANDSCAPE BUFFERS, RETENTION AND DETENTION FACILITIES, EASEMENTS, ETC. UNTIL THE WORK HAS BEEN ACCEPTED BY THE OWNER. ALL DISRUPTED AREAS OUTSIDE THE LIMITS OF WORK SHALL BE RETURNED TO THEIR ORIGINAL CONDITION

1 inch = 20 ft.




23052 DATE: 04/01/24 GRAPHIC SCALE SCALE: 1" = 20' DRAWN BY: DJS APPROVED BY: JCO ( IN FEET )


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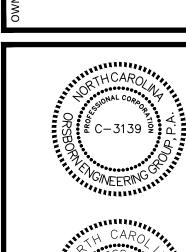
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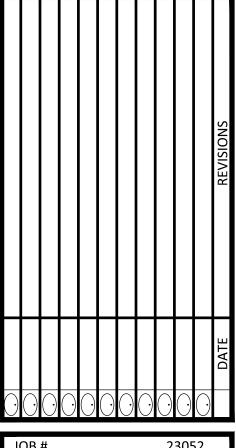
STORM PROFILES MADISON PARK OUTPARCEL 2

'AXHAW, NORTH CA

ADISON WAXHAW OWNER, LLC

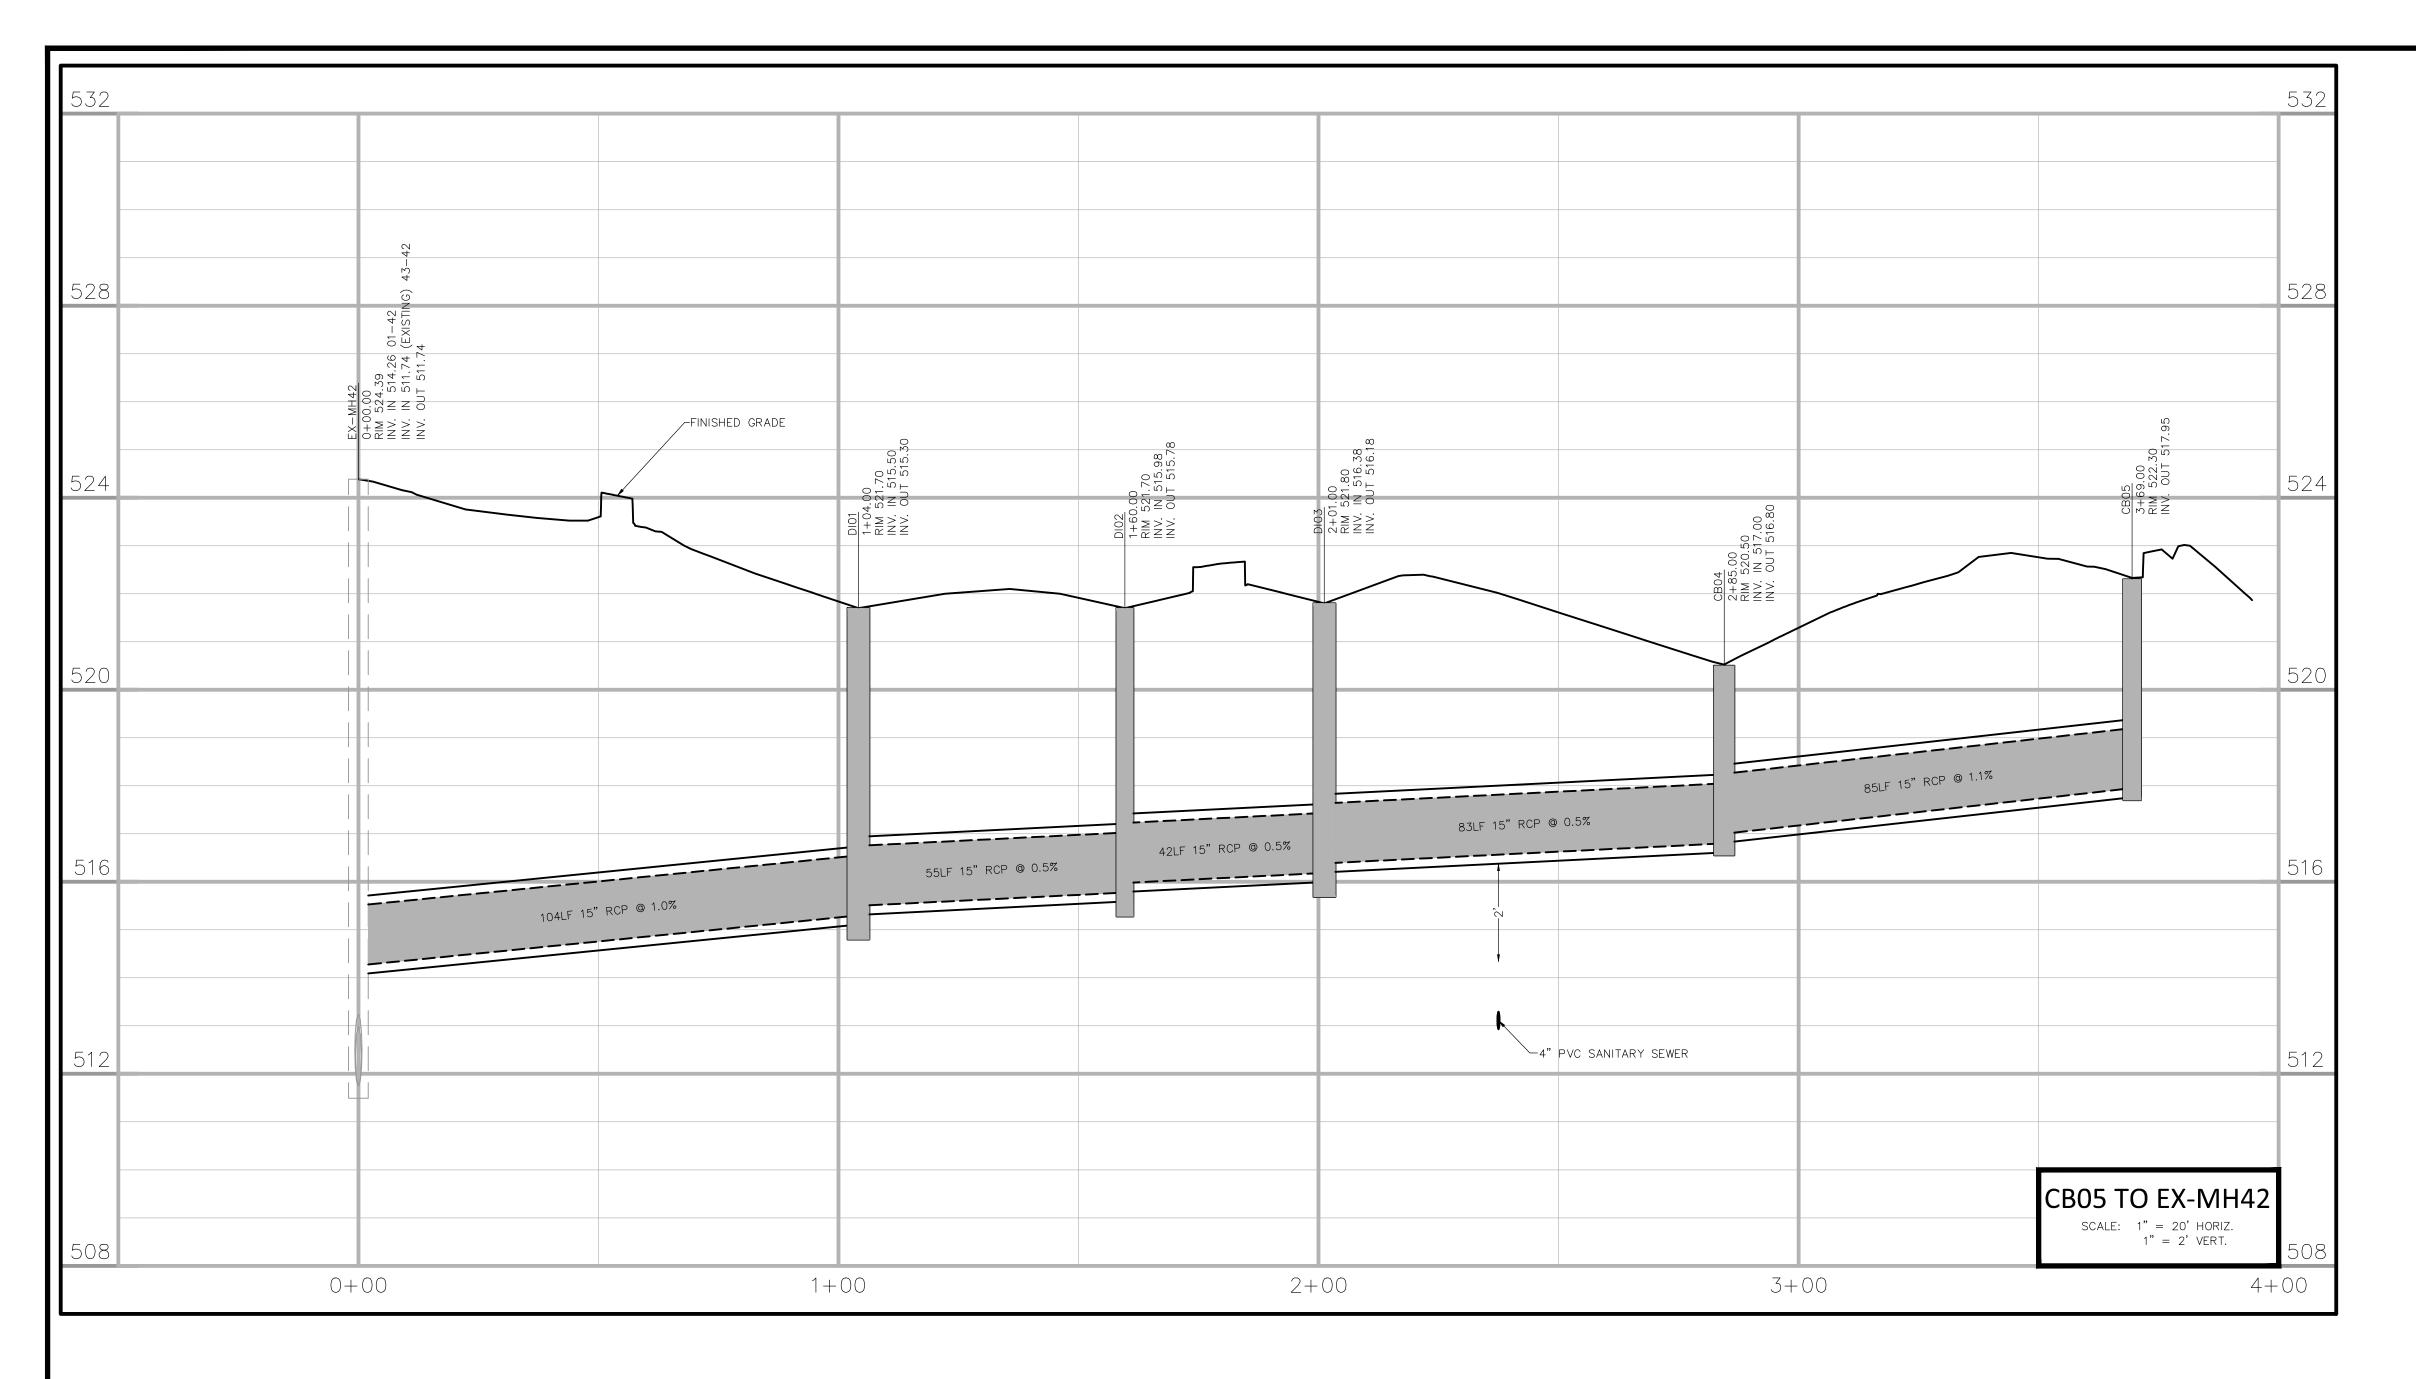




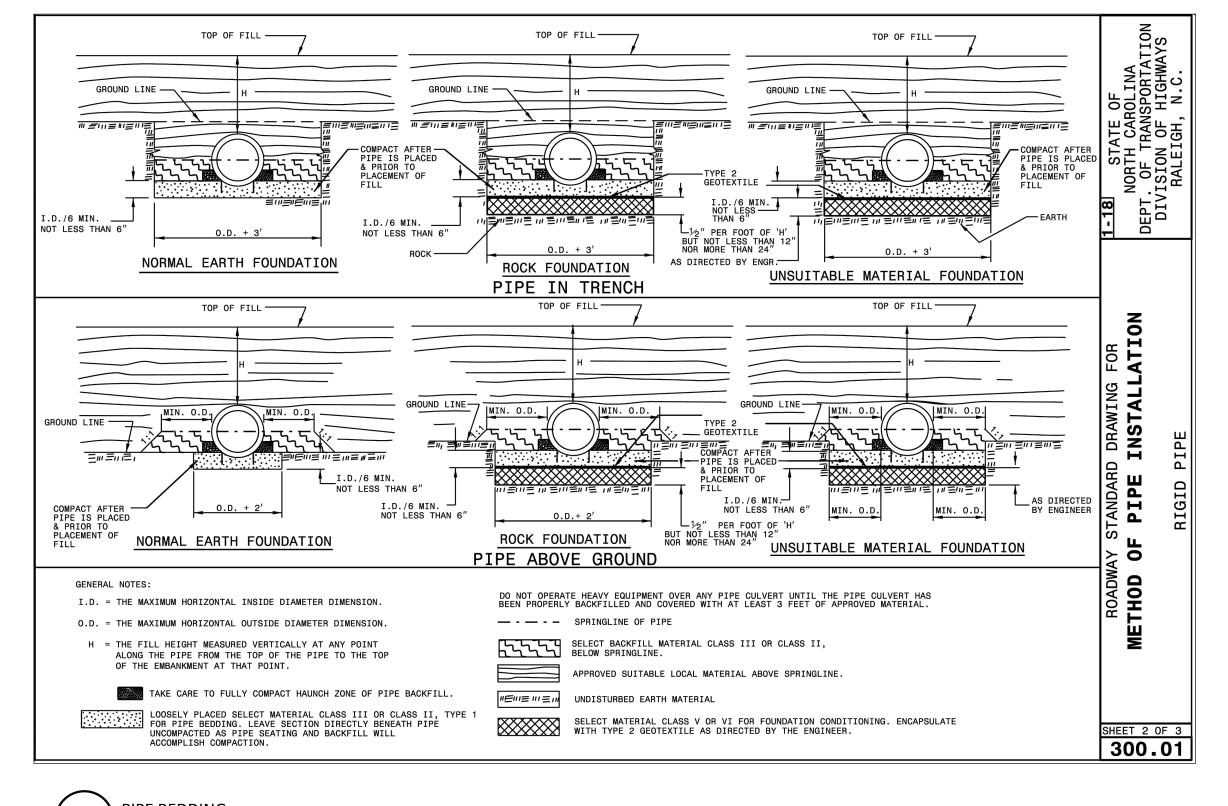

23052 DATE: 04/01/24 SCALE: 1" = 40' DRAWN BY: DJS APPROVED BY: JCO

PIPE BEDDING

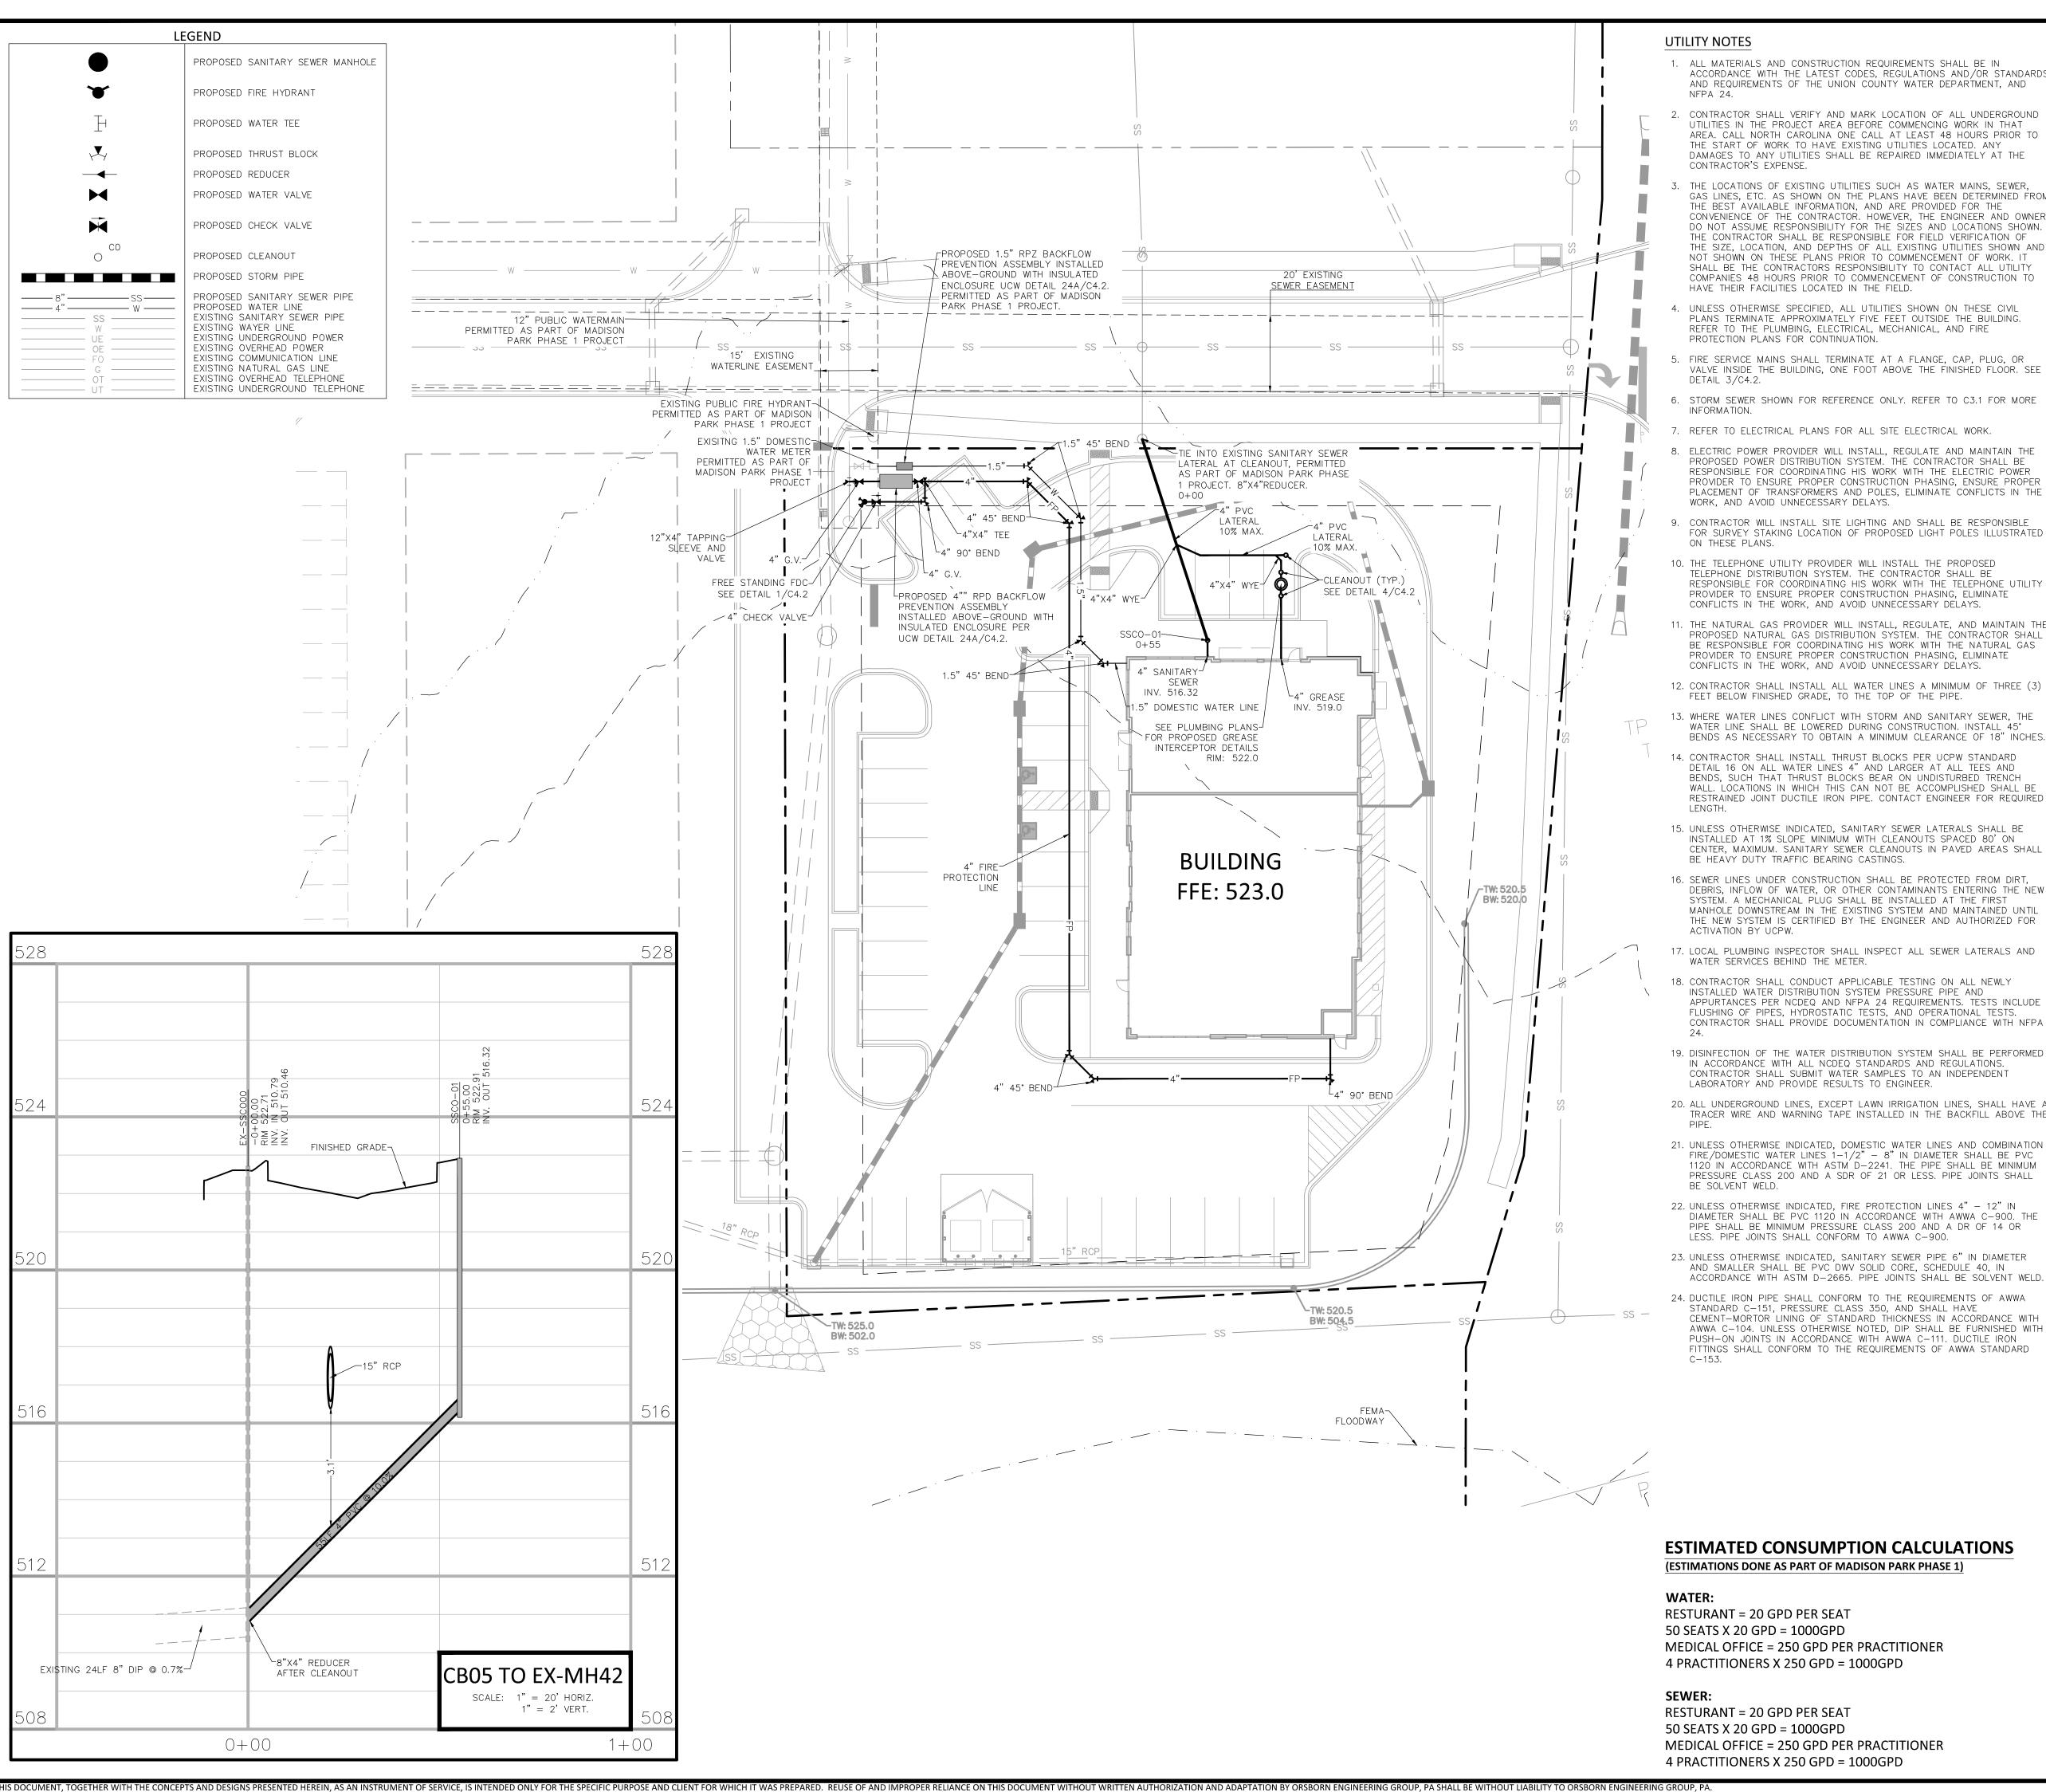

- 1. ALL MATERIALS AND CONSTRUCTION REQUIREMENTS SHALL BE IN ACCORDANCE WITH THE LATEST CODES, REGULATIONS AND/OR STANDARDS AND REQUIREMENTS OF THE UNION COUNTY WATER DEPARTMENT, AND
- 2. CONTRACTOR SHALL VERIFY AND MARK LOCATION OF ALL UNDERGROUND UTILITIES IN THE PROJECT AREA BEFORE COMMENCING WORK IN THAT AREA. CALL NORTH CAROLINA ONE CALL AT LEAST 48 HOURS PRIOR TO THE START OF WORK TO HAVE EXISTING UTILITIES LOCATED. ANY DAMAGES TO ANY UTILITIES SHALL BE REPAIRED IMMEDIATELY AT THE
- . THE LOCATIONS OF EXISTING UTILITIES SUCH AS WATER MAINS, SEWER, GAS LINES, ETC. AS SHOWN ON THE PLANS HAVE BEEN DETERMINED FROM THE BEST AVAILABLE INFORMATION, AND ARE PROVIDED FOR THE CONVENIENCE OF THE CONTRACTOR. HOWEVER, THE ENGINEER AND OWNER DO NOT ASSUME RESPONSIBILITY FOR THE SIZES AND LOCATIONS SHOWN. THE CONTRACTOR SHALL BE RESPONSIBLE FOR FIELD VERIFICATION OF THE SIZE, LOCATION, AND DEPTHS OF ALL EXISTING UTILITIES SHOWN AND NOT SHOWN ON THESE PLANS PRIOR TO COMMENCEMENT OF WORK. IT SHALL BE THE CONTRACTORS RESPONSIBILITY TO CONTACT ALL UTILITY COMPANIES 48 HOURS PRIOR TO COMMENCEMENT OF CONSTRUCTION TO HAVE THEIR FACILITIES LOCATED IN THE FIELD.
- UNLESS OTHERWISE SPECIFIED, ALL UTILITIES SHOWN ON THESE CIVIL PLANS TERMINATE APPROXIMATELY FIVE FEET OUTSIDE THE BUILDING. REFER TO THE PLUMBING, ELECTRICAL, MECHANICAL, AND FIRE
- PROTECTION PLANS FOR CONTINUATION. . FIRE SERVICE MAINS SHALL TERMINATE AT A FLANGE, CAP, PLUG, OR
- 6. STORM SEWER SHOWN FOR REFERENCE ONLY. REFER TO C3.1 FOR MORE
- 7. REFER TO ELECTRICAL PLANS FOR ALL SITE ELECTRICAL WORK.
- 8. ELECTRIC POWER PROVIDER WILL INSTALL, REGULATE AND MAINTAIN THE PROPOSED POWER DISTRIBUTION SYSTEM. THE CONTRACTOR SHALL BE RESPONSIBLE FOR COORDINATING HIS WORK WITH THE FLECTRIC POWER PROVIDER TO ENSURE PROPER CONSTRUCTION PHASING, ENSURE PROPER PLACEMENT OF TRANSFORMERS AND POLES, ELIMINATE CONFLICTS IN THE
- 9. CONTRACTOR WILL INSTALL SITE LIGHTING AND SHALL BE RESPONSIBLE FOR SURVEY STAKING LOCATION OF PROPOSED LIGHT POLES ILLUSTRATED
- 10. THE TELEPHONE UTILITY PROVIDER WILL INSTALL THE PROPOSED TELEPHONE DISTRIBUTION SYSTEM. THE CONTRACTOR SHALL BE RESPONSIBLE FOR COORDINATING HIS WORK WITH THE TELEPHONE UTILITY PROVIDER TO ENSURE PROPER CONSTRUCTION PHASING, ELIMINATE
- 11. THE NATURAL GAS PROVIDER WILL INSTALL, REGULATE, AND MAINTAIN THE PROPOSED NATURAL GAS DISTRIBUTION SYSTEM. THE CONTRACTOR SHALL BE RESPONSIBLE FOR COORDINATING HIS WORK WITH THE NATURAL GAS PROVIDER TO ENSURE PROPER CONSTRUCTION PHASING, ELIMINATE
- 12. CONTRACTOR SHALL INSTALL ALL WATER LINES A MINIMUM OF THREE (3)
- 13. WHERE WATER LINES CONFLICT WITH STORM AND SANITARY SEWER, THE WATER LINE SHALL BE LOWERED DURING CONSTRUCTION. INSTALL 45° BENDS AS NECESSARY TO OBTAIN A MINIMUM CLEARANCE OF 18" INCHES.
- 14. CONTRACTOR SHALL INSTALL THRUST BLOCKS PER UCPW STANDARD DETAIL 16 ON ALL WATER LINES 4" AND LARGER AT ALL TEES AND BENDS, SUCH THAT THRUST BLOCKS BEAR ON UNDISTURBED TRENCH WALL. LOCATIONS IN WHICH THIS CAN NOT BE ACCOMPLISHED SHALL BE RESTRAINED JOINT DUCTILE IRON PIPE. CONTACT ENGINEER FOR REQUIRED
- 15. UNLESS OTHERWISE INDICATED, SANITARY SEWER LATERALS SHALL BE INSTALLED AT 1% SLOPE MINIMUM WITH CLEANOUTS SPACED 80' ON CENTER, MAXIMUM. SANITARY SEWER CLEANOUTS IN PAVED AREAS SHALL BE HEAVY DUTY TRAFFIC BEARING CASTINGS.
- 16. SEWER LINES UNDER CONSTRUCTION SHALL BE PROTECTED FROM DIRT. DEBRIS, INFLOW OF WATER, OR OTHER CONTAMINANTS ENTERING THE NEW SYSTEM. A MECHANICAL PLUG SHALL BE INSTALLED AT THE FIRST MANHOLE DOWNSTREAM IN THE EXISTING SYSTEM AND MAINTAINED UNTIL THE NEW SYSTEM IS CERTIFIED BY THE ENGINEER AND AUTHORIZED FOR
- 17. LOCAL PLUMBING INSPECTOR SHALL INSPECT ALL SEWER LATERALS AND
- 18. CONTRACTOR SHALL CONDUCT APPLICABLE TESTING ON ALL NEWLY INSTALLED WATER DISTRIBUTION SYSTEM PRESSURE PIPE AND APPURTANCES PER NCDEQ AND NFPA 24 REQUIREMENTS. TESTS INCLUDE FLUSHING OF PIPES, HYDROSTATIC TESTS, AND OPERATIONAL TESTS. CONTRACTOR SHALL PROVIDE DOCUMENTATION IN COMPLIANCE WITH NFPA
- 19. DISINFECTION OF THE WATER DISTRIBUTION SYSTEM SHALL BE PERFORMED IN ACCORDANCE WITH ALL NCDEQ STANDARDS AND REGULATIONS. CONTRACTOR SHALL SUBMIT WATER SAMPLES TO AN INDEPENDENT LABORATORY AND PROVIDE RESULTS TO ENGINEER.
- 20. ALL UNDERGROUND LINES, EXCEPT LAWN IRRIGATION LINES, SHALL HAVE A TRACER WIRE AND WARNING TAPE INSTALLED IN THE BACKFILL ABOVE THE
- 21. UNLESS OTHERWISE INDICATED, DOMESTIC WATER LINES AND COMBINATION FIRE/DOMESTIC WATER LINES 1-1/2" - 8" IN DIAMETER SHALL BE PVC 1120 IN ACCORDANCE WITH ASTM D-2241. THE PIPE SHALL BE MINIMUM PRESSURE CLASS 200 AND A SDR OF 21 OR LESS. PIPE JOINTS SHALL
- 22. UNLESS OTHERWISE INDICATED, FIRE PROTECTION LINES 4" 12" IN DIAMETER SHALL BE PVC 1120 IN ACCORDANCE WITH AWWA C-900. THE PIPE SHALL BE MINIMUM PRESSURE CLASS 200 AND A DR OF 14 OR LESS. PIPE JOINTS SHALL CONFORM TO AWWA C-900.
- 23. UNLESS OTHERWISE INDICATED, SANITARY SEWER PIPE 6" IN DIAMETER AND SMALLER SHALL BE PVC DWV SOLID CORE, SCHEDULE 40, IN ACCORDANCE WITH ASTM D-2665. PIPE JOINTS SHALL BE SOLVENT WELD.
- 24. DUCTILE IRON PIPE SHALL CONFORM TO THE REQUIREMENTS OF AWWA STANDARD C-151, PRESSURE CLASS 350, AND SHALL HAVE CEMENT-MORTOR LINING OF STANDARD THICKNESS IN ACCORDANCE WITH AWWA C-104. UNLESS OTHERWISE NOTED, DIP SHALL BE FURNISHED WITH PUSH-ON JOINTS IN ACCORDANCE WITH AWWA C-111. DUCTILE IRON FITTINGS SHALL CONFORM TO THE REQUIREMENTS OF AWWA STANDARD




**VICINITY MAP** NOT TO SCALE

#### **UCPW UTILITY NOTES**

- 1) REFER TO UNION COUNTY SPECIFICATIONS, UNION COUNTY WATER & SEWER EXTENSION POLICY AND UNION COUNTY WATER & SEWER EXTENSION ORDINANCE
- 2) WATER AND SEWER TAPS, MATERIALS AND INSTALLATION TO BE BY THE DEVELOPER. METER TO BE SET BY UCW AT PREVAILING RATE
- 3) ENGINEER TO CERTIFY THAT DESIGN HAS BEEN VERIFIED BY GROUND
- 4) A UNION COUNTY WATER'S UTILITY RIGHT-OF-WAY SHALL EXIST ON ALL SANITARY SEWER LATERALS, WATER METERS, AND FIRE HYDRANTS. THE UTILITY RIGHT-OF WAY IS LOCATED 5 FEET ALL SIDES FROM THE CLEANOUT, WATER METER, OR FIRE HYDRANT TO THE PUBLIC OR PRIVATE ROAD RIGHT-OF-WAY.
- 5) THE PROPERTY OWNER SHALL NOT CONSTRUCT OR PERMIT CONSTRUCTION OR PLACEMENT OF ANY TYPE STRUCTURE, PLANT TREES, OR MAKE USE OF THE EASEMENT AREA IN ANY MANNER THAT WILL RESULT IN INTERFERENCE, INTERRUPTION, OR IMPEDIMENT OF UNION COUNTY WATER EASEMENT AND INGRESS/EGRESS.
- 6) ANY CHANGES MADE TO THE PLANS FOR OTHER DISCIPLINES (STORM WATER, EROSION, TREES, LANDSCAPING, ETC.) MUST BE SHOWN AND IDENTIFIED BY REVISION NUMBER AND CLOUDING. FAILURE TO DO SO WILL DELAY THE APPROVAL OF THIS PROJECT.
- 7) DESIGN ENGINEER SHALL CONFIRM THAT WATER AND SEWER MAINS AS WELL AS SERVICE LINES, METER BOXES, FIRE HYDRANTS AND LATERALS WILL NOT BE IN CONFLICT WITH ANY PROPOSED UTILITY INSTALLATION, LANDSCAPING AND/OR DRIVEWAYS. ANY CONFLICTS SHALL BE AT THE DEVELOPER'S EXPENSE TO COORDINATE AND RESOLVE AND COULD RESULT IN DELAY OF WATER METERS BEING SET.
- 8) ONLY UCW PERSONNEL WILL OPERATE THE ACTIVE VALVES WHICH INCLUDED THE TAPPING VALVE.
- 9) FIRE HYDRANT PLACEMENT (FIRE HYDRANTS SHALL BE PLACED A MINIMUM DISTANCE OF 6 FEET BACK OF CURB AND GUTTER SECTIONS AND BACK OF DITCH IN ROADWAY SECTIONS) & HAVE A CLEAR SPACE OF 5 FEET FROM ANY PERMANENT STRUCTURES.
- 10) METERS WILL NOT BE SET IF WATER METER BOXES. SEWER CLEAN-OUTS. VALVE BOXES OR THEIR APPURTENANCES ARE DAMAGED OR IMPROPERLY
- 11) 2"GATE VALVES SHALL BE AWWA C515 COMPLIANT
- 12) 2"GATE VALVES SHALL BE NSF 61 COMPLIANT
- 13) 3"OR LARGER GATE VALVES SHALL BE AWWA C500 AND C509 COMPLIANT
- 14) AIR RELEASE VALVES SHALL BE AWWA C512 COMPLIANT

MAIN AT UCW DISCRETION.

- 15) VERIFICATION HAS BEEN MADE BY ORSBORN ENGINEERING THAT EACH LOT IS CAPABLE OF HAVING GRAVITY SEWER SERVICE TO THE CENTER OF THE LOT AT THE FRONT SETBACK
- 16) ALL PROPOSED SEWER CONNECTIONS TO THE EXISTING SEWER SYSTEM BY STRADDLE MANHOLE SHALL NOT CUT INTO THE EXISTING SEWER PIPE UNTIL THE PROPOSED SEWER LINE HAS BEEN ACCEPTED BY UCW. ALSO. ALL CORE CONNECTIONS TO EXISTING MANHOLES MUST BE PLUGGED WITH A CONCRETE PLUG IN THE INVERT OUT AT THE 1ST PROPOSED MH UPSTREAM OF THE TIE IN THE SEWER PLUG SHALL NOT BE REMOVED UNTIL THE PROPOSED SEWER LINE HAS BEEN ACCEPTED BY UCW. IF PLUG IS REMOVED PREMATURELY OR EXISTING PIPE IS DAMAGED THE CONTRACTOR MAY BE LIABLE FOR CLEANING ALL DOWNSTREAM SEWER
- 17) THE CONTRACTOR SHALL AT ALL TIMES PROVIDE AND MAINTAIN AMPLE MEANS AND EQUIPMENT WITH WHICH TO REMOVE AND PROPERLY DISPOSE OF ANY AND ALL WATER ENTERING THE EXCAVATION OR OTHER PARTS OF THE WORK AND KEEP ALL EXCAVATIONS DRY UNTIL SUCH TIME AS PIPE LAYING AND GRADING IS COMPLETED AND STRUCTURES 1 BE BUILT THEREIN ARE COMPLETED. NO WATER SHALL BE ALLOWED T RISE AROUND THE PIPE IN UN-BACKFILLED TRENCHES NOR SHALL IT ALLOWED TO RISE OVER MASONRY UNTIL THE CONCRETE OR MORTAR HAS SET (MINIMUM 24 HOURS). ALL WATER PUMPED OR DRAINED FROM THE WORK SHALL BE DISPOSED OF IN SUCH A MANNER AS TO PREVENT SILTATION AND EROSION TO ADJACENT PROPERTY OR OTHER CONSTRUCTION.
- 18) IF WELL AND/OR SEPTIC SYSTEMS ARE ENCOUNTERED, THEN CONTACT DAVID FINLEY (704.283.3879) WITH ENVIRONMENTAL HEALTH FOR THEIR SEQUENCE OF EVENTS AND OTHER PERTINENT INFORMATION.
- 19) UCW IS NOT RESPONSIBLE FOR THE MAINTENANCE OF THE WALKING TRAIL AND WILL NOT BE RESPONSIBLE FOR REPAIRS OF THE WALKING TRAIL DUE TO MAINTENANCE OF THE SEWER LINE.
- 20) THE CONTRACTOR SHALL CONTACT UNION COUNTY WATER PERSONNEL AFTER MATERIALS HAVE BEEN APPROVED BY UNION COUNTY WATER AND AT LEAST 48 HOURS BEFORE BEGINNING CONSTRUCTION TO SCHEDULE A PRECONSTRUCTION MEETING. PLEASE REACH OUT TO LEE DILLON AT LEE.DILLON@UNIONCOUNTYNC.GOV TO SCHEDULE THE MEETING.
- 21) ANY WORK OR TEST PERFORMED WITHOUT NOTIFICATION AND CONTACT WITH FIELD INSPECTORS SHALL BE INSTALLED AT THE CONTRACTOR'S RISK AND SUBJECT TO REMOVAL.

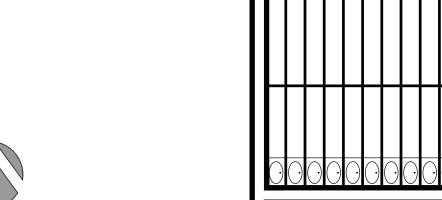

JOB#	23052
DATE:	04/01/24
SCALE:	1" = 20'
DRAWN BY:	DJS
APPROVED BY:	JCO
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**8** 

MADISON F OUTPARCI


#### **ESTIMATED CONSUMPTION CALCULATIONS** (ESTIMATIONS DONE AS PART OF MADISON PARK PHASE 1)

RESTURANT = 20 GPD PER SEAT 50 SEATS X 20 GPD = 1000GPD MEDICAL OFFICE = 250 GPD PER PRACTITIONER 4 PRACTITIONERS X 250 GPD = 1000GPD

RESTURANT = 20 GPD PER SEAT 50 SEATS X 20 GPD = 1000GPD MEDICAL OFFICE = 250 GPD PER PRACTITIONER 4 PRACTITIONERS X 250 GPD = 1000GPD

GRAPHIC SCALE

( IN FEET ) 1 inch = 20 ft.

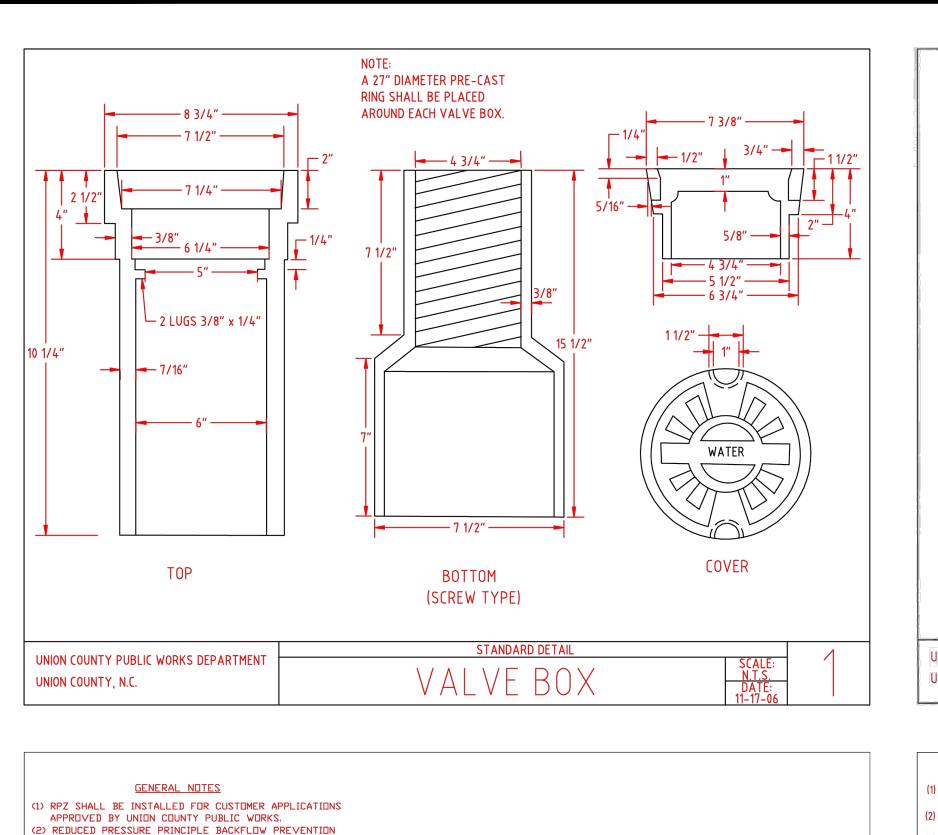

REDUCED PRESSURE PRINCIPLE BACKFLOW PREVENTION ASSEMBLY

-CLASS 1 OR CLASS 2, ASSE

ENCLOSURE ANCHORED TO

CONCRETE OR APPROVED

FIBERGLASS MOUNTING PAD

- 120 VOLT GFCI ELECTRICAL RECEPTACLE

-DRAIN PORT - PROVIDE

POSITIVE DRAINAGE OUT OF ENCLOSURE (MINIMUM TWICE

1060 INSULATED WEATHERPROOF

VARIES
(SEE MANUFACTURER)

STANDARD DETAIL

REDUCED PRESSURE ZONE ASSEMBLY

ASSEMBLY SHALL COMPLY WITH ASSE 1013 & AWWA C511

3) OWNER SHALL PROVIDE WRITTEN CERTIFICATION TO THE

D) BACKFLOW PREVENTION ASSEMBLY SHALL BE

7) PIPE MATERIAL SHALL BE BRASS (ASTM B43).

9) PROPERTY OWNER SHALL BE RESPONSIBLE FOR MAINTENANCE AND OPERATION OF BACKFLOW ASSEMBLY AND COMPLIANCE WITH REPORTING AND

UNION COUNTY PUBLIC WORKS DEPARTMENT

UNION COUNTY, N.C.

TESTING REQUIREMENTS.

CENTERED ON CONCRETE OR APPROVED FIBERGLASS

5) REDUCER PRESSURE ZONE ASSEMBLY SHALL BE ABOVE

DUTSIDE OF THE RIGHT OF WAY, MAXIMUM OF 5 FEET.

(8) INSTALLATION SHALL BE IN COMPLIANCE WITH ALL APPLICABLE COUNTY ORDINANCES AND SPECIFICATIONS IN ADDITION TO THE N.C. PLUMBING CODE.


BACKFLOW PREVENTION ASSEMBLY SHALL BE INSTALLED


MOUNTING PAD AND CENTERED WITHIN ENCLOSURE.


COUNTY THAT THE RPZ HAS BEEN TESTED BY A CERTIFIED


BACKFLOW PREVENTION TECHNICIAN AFTER INSTALLATION.


(FEBCO 825Y, WILKINS MODEL 975XL, HERSEY MODEL FRPII OR EQUAL).

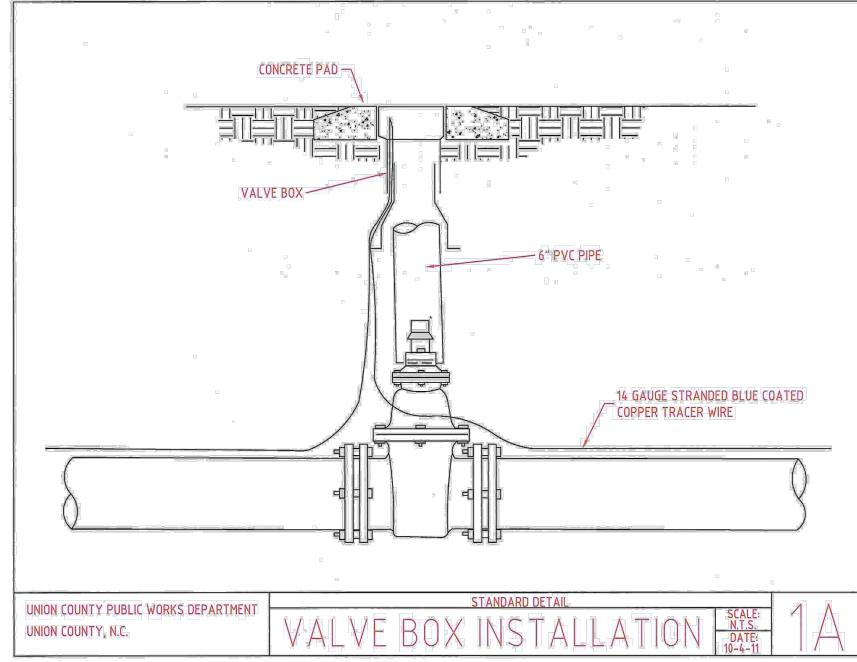


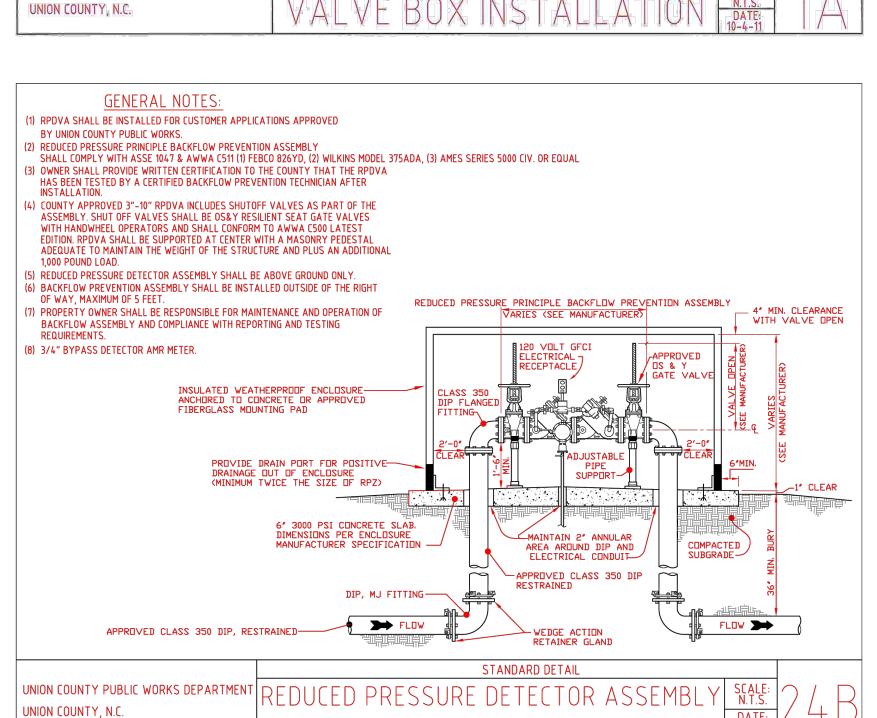

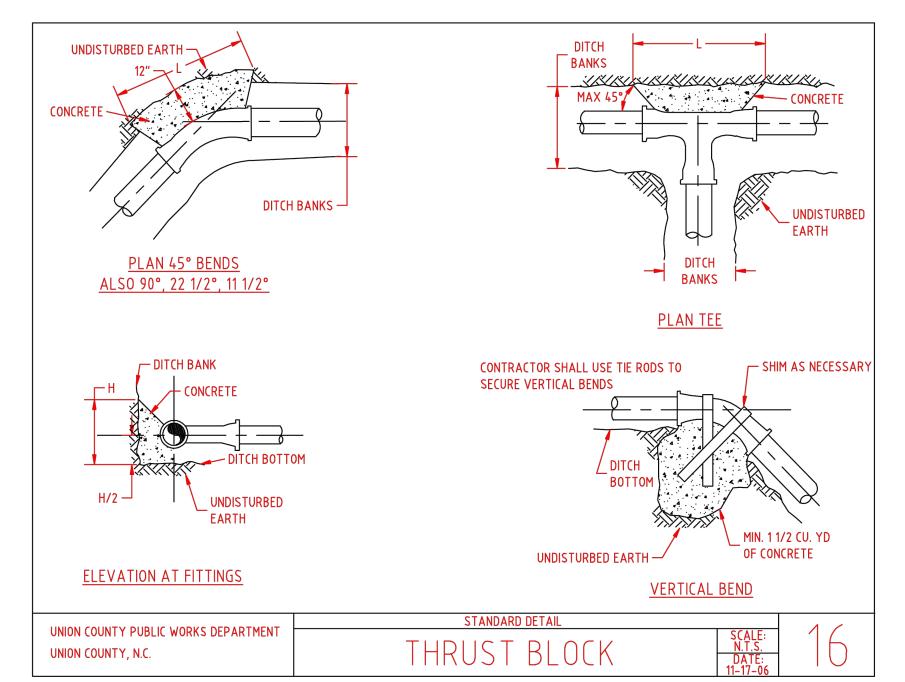

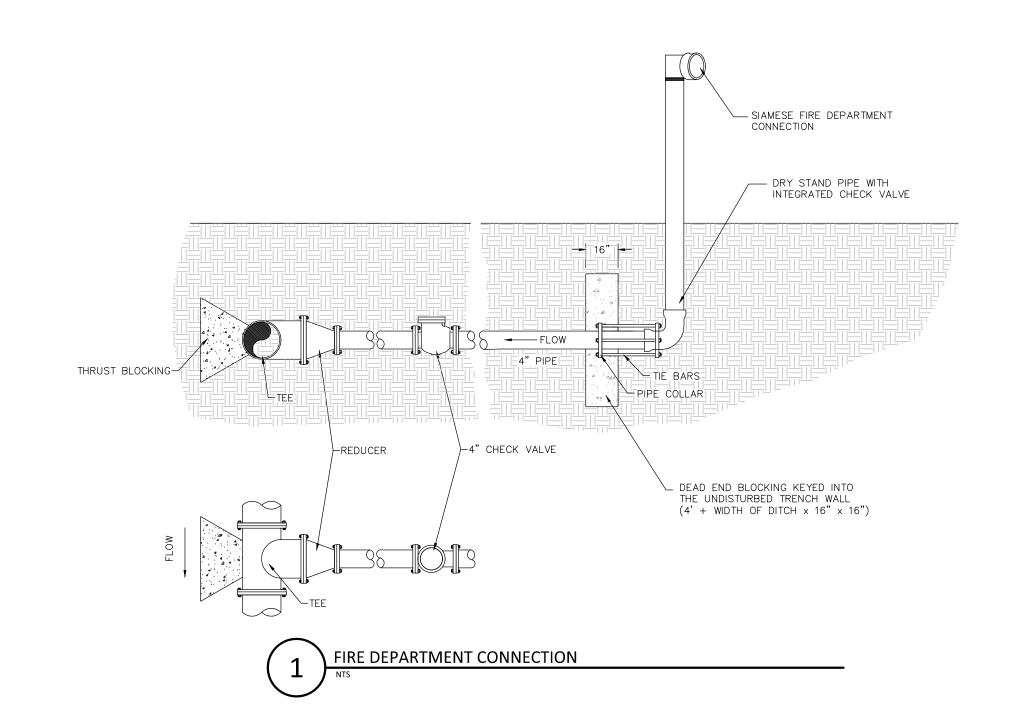


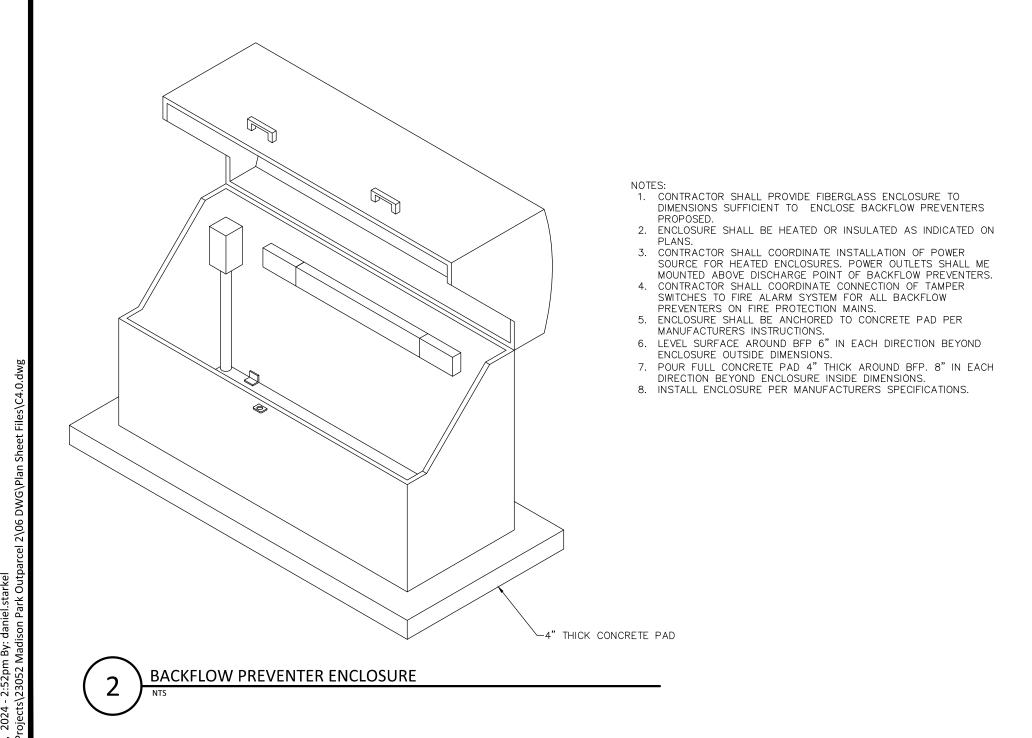


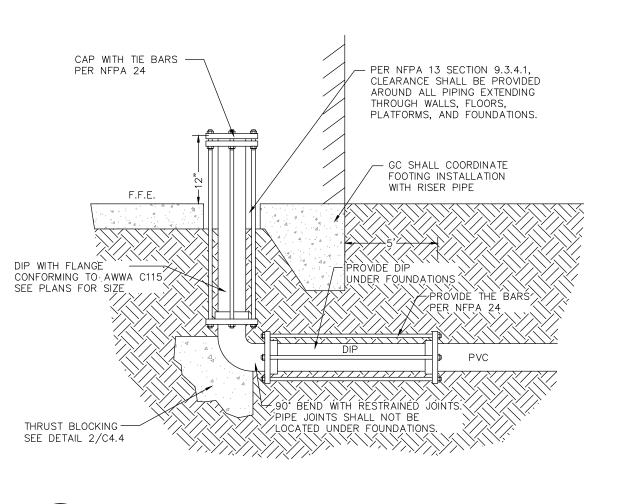

FIRE PROTECTION MAIN RISER

HIS DOCUMENT, TOGETHER WITH THE CONCEPTS AND DESIGNS PRESENTED HEREIN, AS AN INSTRUMENT OF SERVICE, IS INTENDED ONLY FOR THE SPECIFIC PURPOSE AND CLIENT FOR WHICH IT WAS PREPARED. REUSE OF AND IMPROPER RELIANCE ON THIS DOCUMENT WITHOUT WRITTEN AUTHORIZATION AND ADAPTATION BY ORSBORN ENGINEERING GROUP, PA.

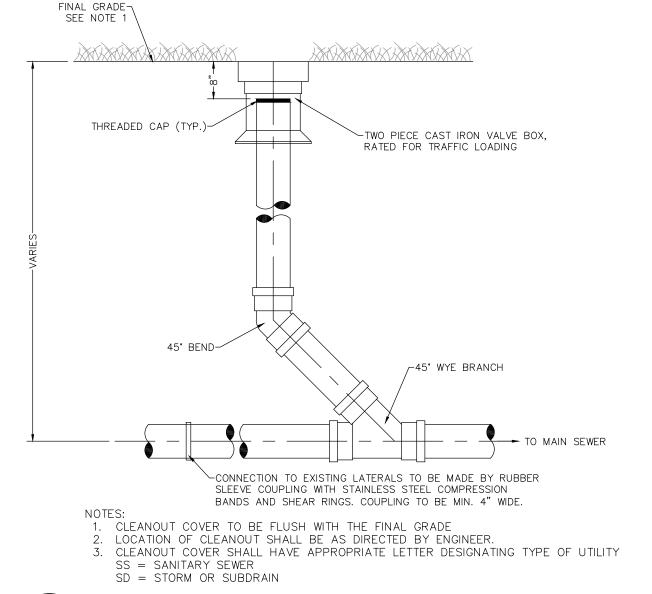

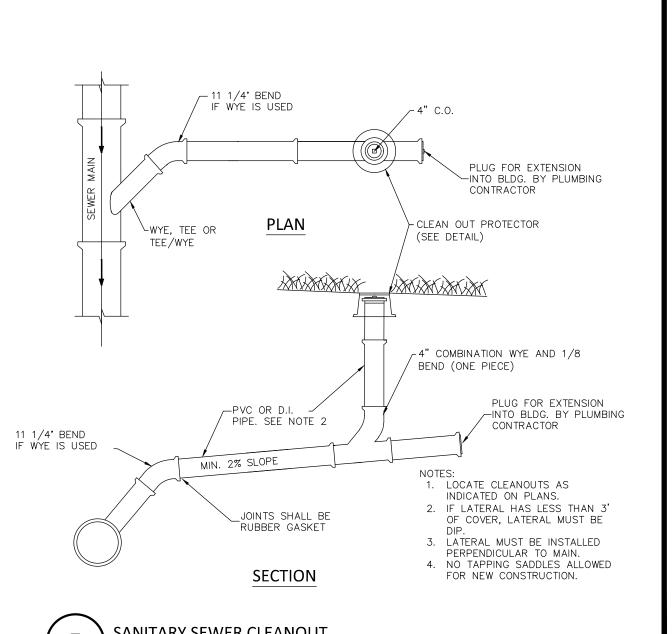



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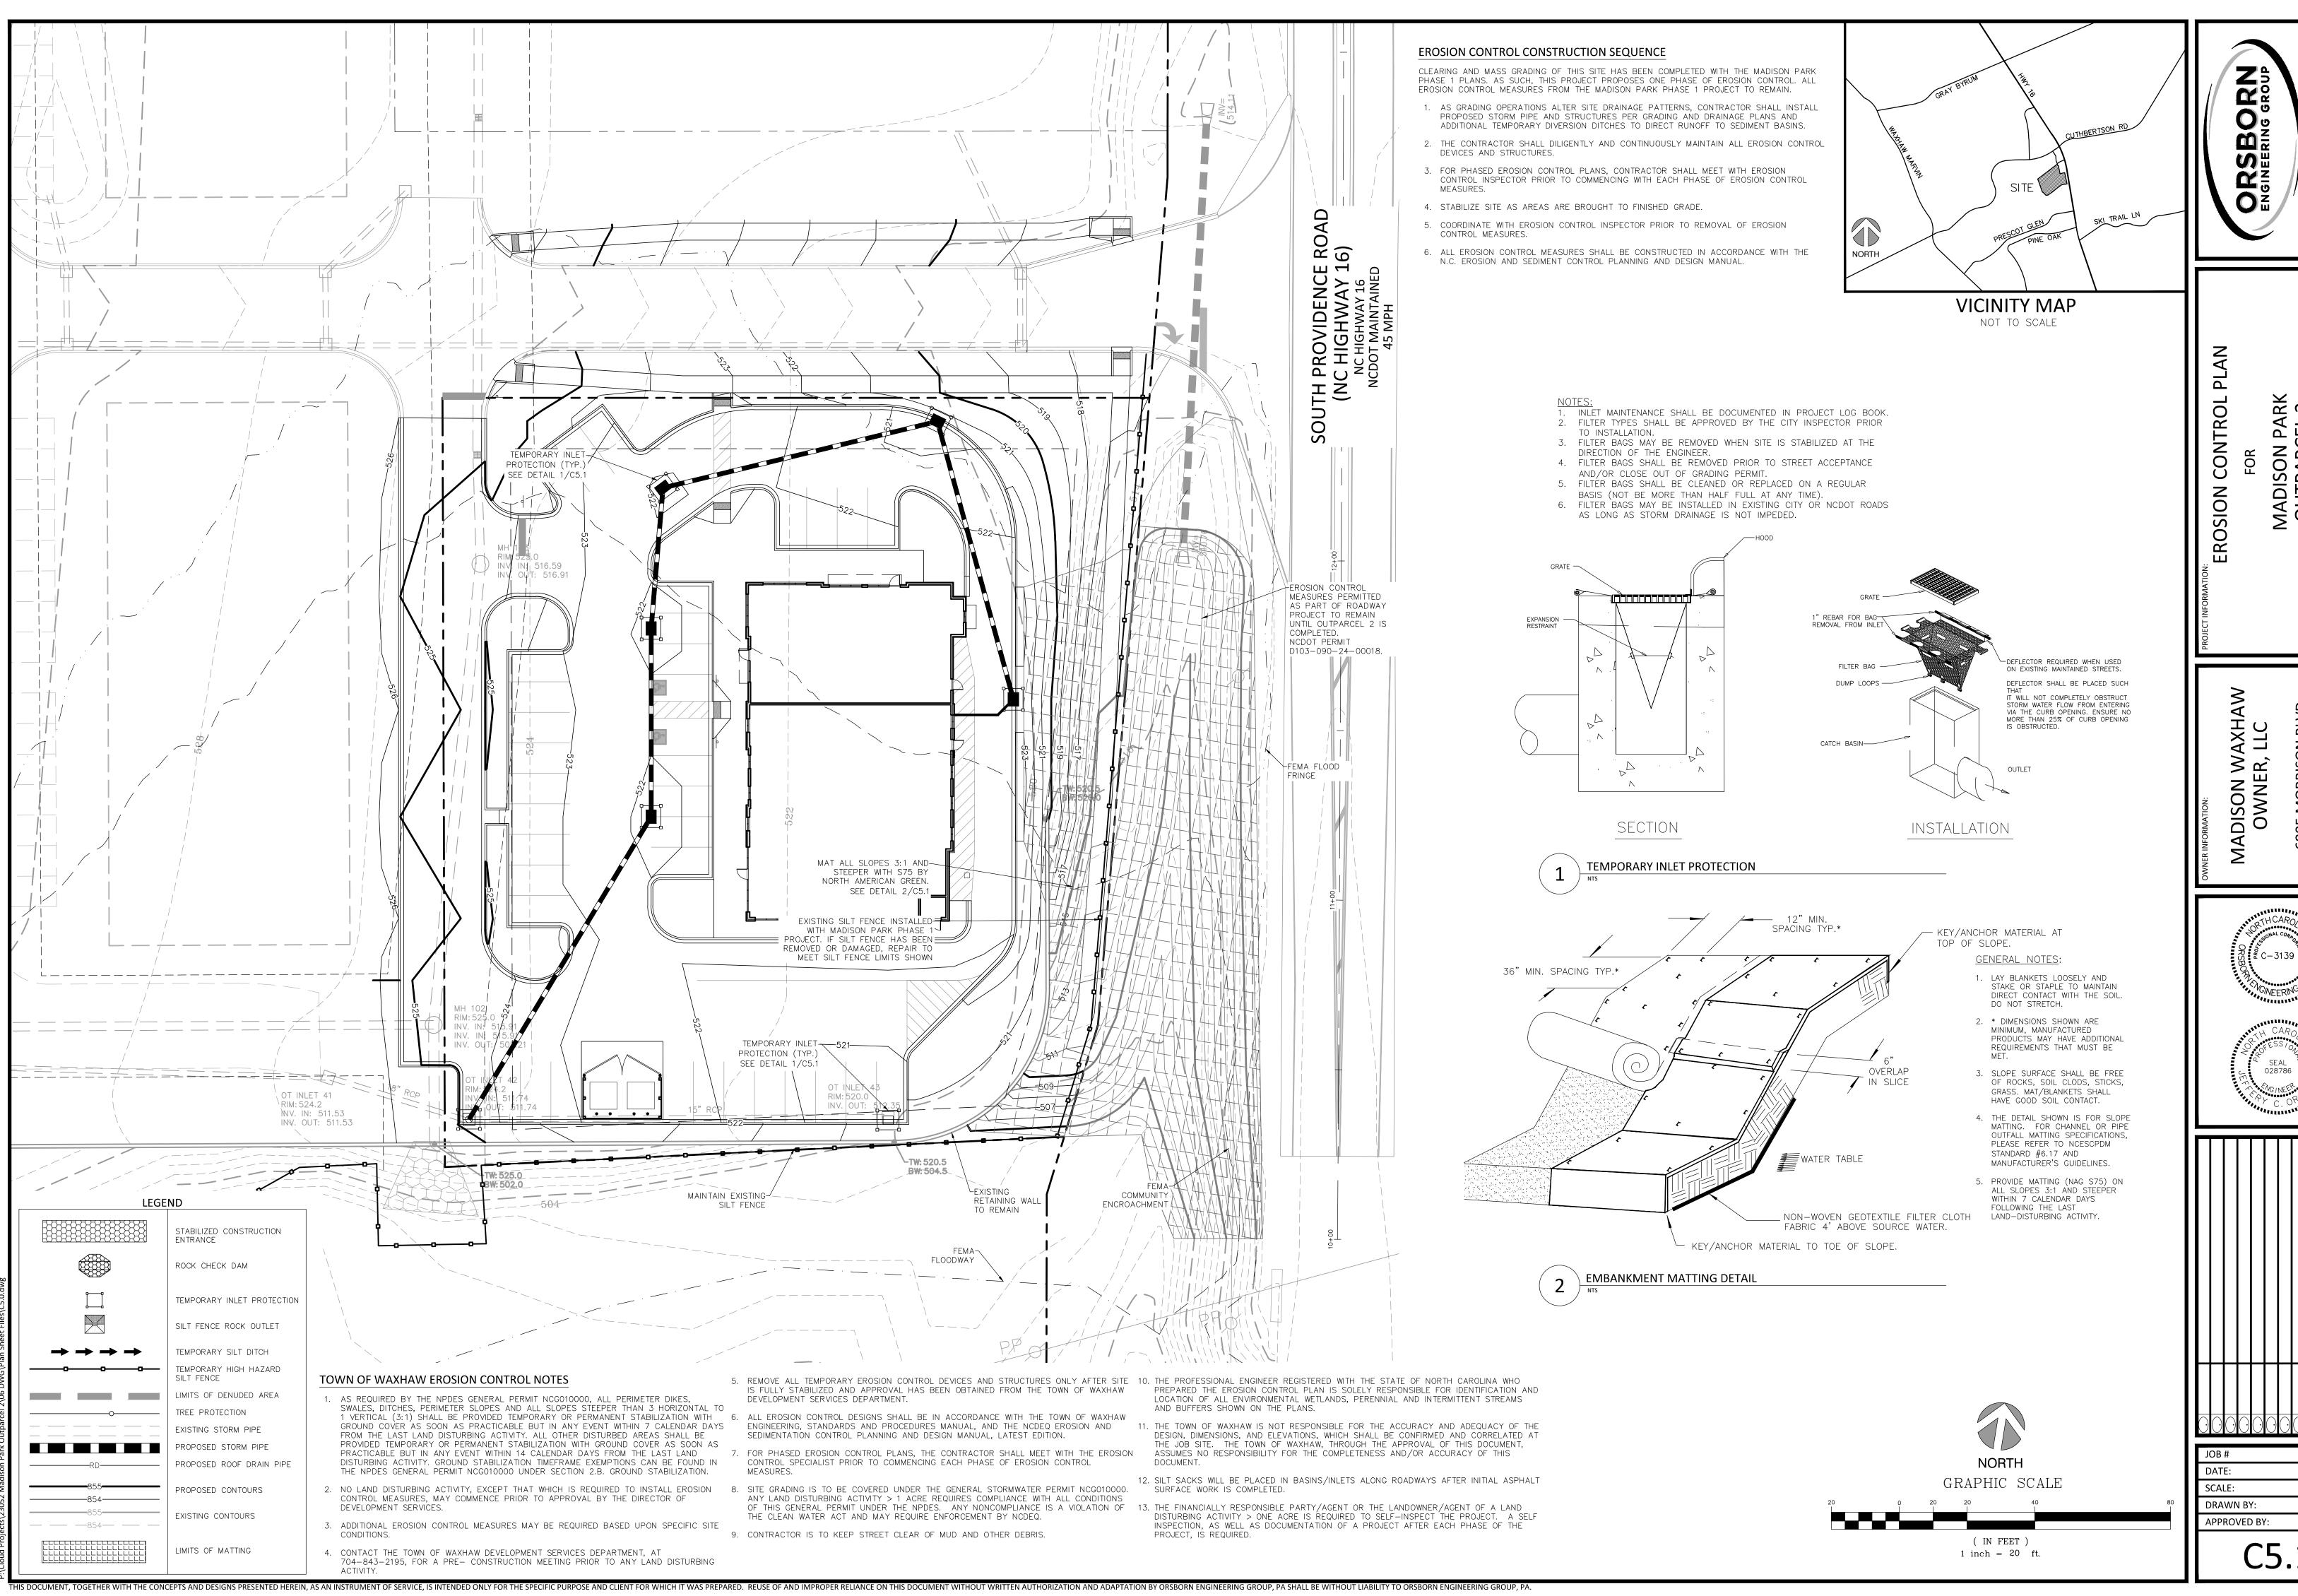
UTILITY DETAIL ス 2 MADISON PAF OUTPARCEL 2

NORTH


DISON WAXHAW OWNER, LLC



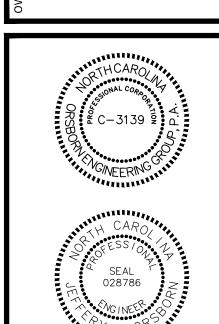


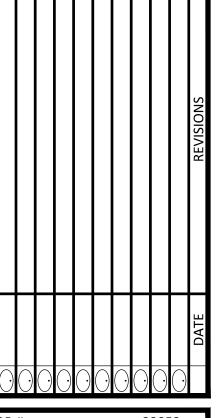

**8** PA EL MADISON F OUTPARCE

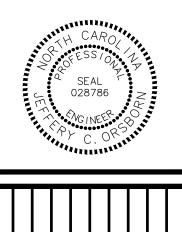

23052 04/01/24 1" = 20' DJS JCO

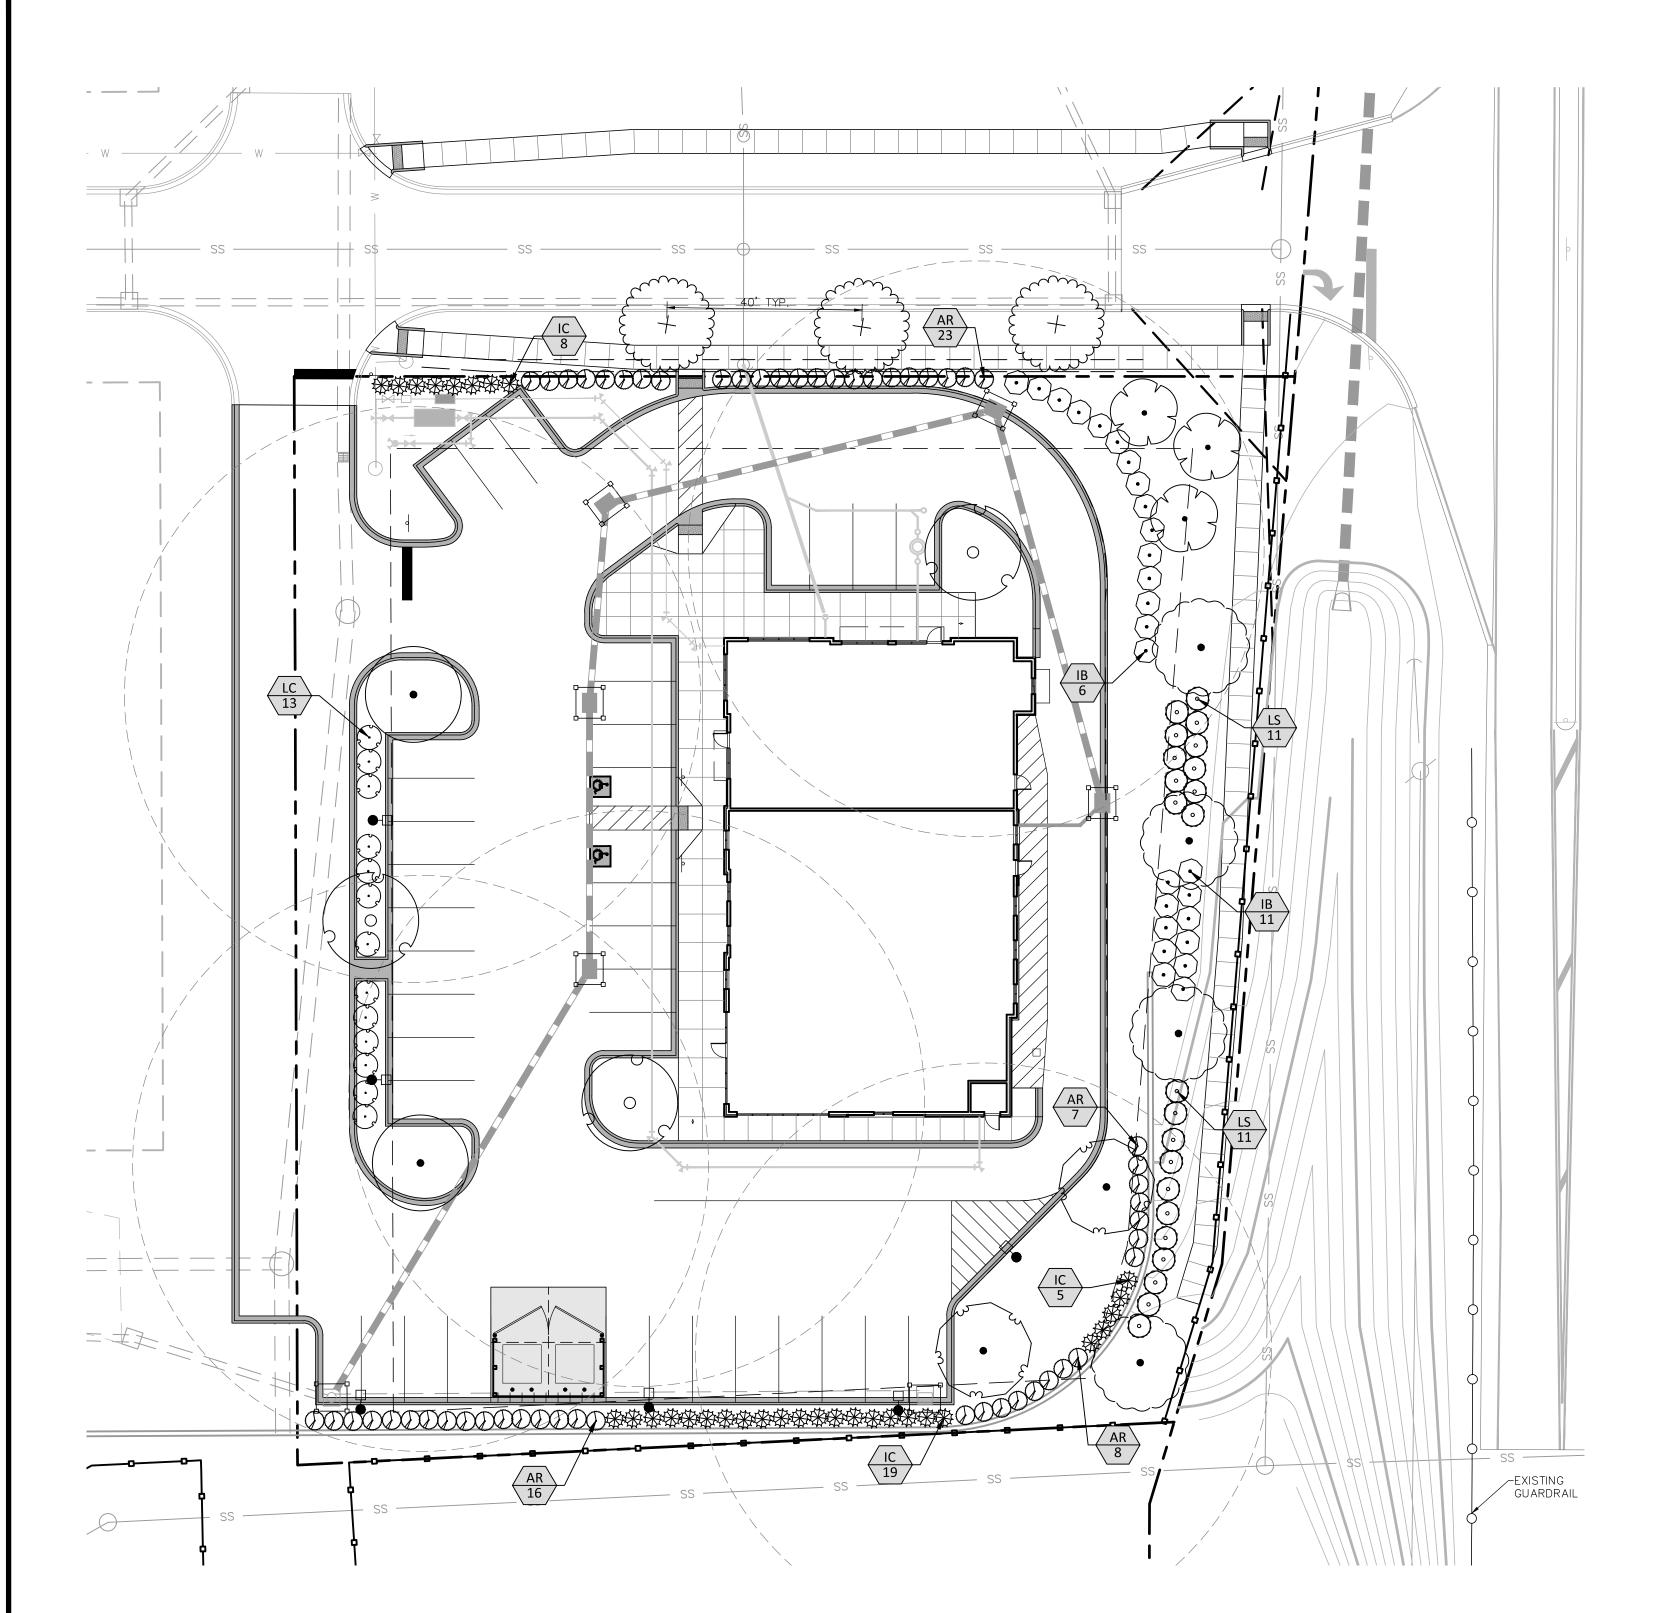

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# TREE PLANTING SUMMARY

TOTAL SITE AREA = 1.01 ACRES

### LANDSCAPING YARD REQUIREMENTS:

WITHIN RIGHT-OF-WAY: ONE MEDIUM TO LARGE TREE SPACED 40-65 FT O.C. IN DESIGNATED PLANTING STRIP.

PRIVATE UNNAMED ROAD: 3 LARGE TREES PROVIDED @ 40' O.C.

SOUTH PROVIDENCE ROAD: REQUIREMENT CANNOT BE FULFILLED DUE TO CURRENT SITE CONDITIONS.

FRONT YARD: ONE MEDIUM TO LARGE MATURING TREE WITHIN 25 FT OF SIDEWALK SPACED 40-65 FT O.C. SHRUBS MAY BE USED TO ENHANCE THE AESTHETICS OF THE STREETSCAPE AREA AND PROVIDE SEPARATION BETWEEN DEVELOPMENT AND ROADWAY.

PROVIDED: 7 TREES, 99 SHRUBS

# PARKING LOT LANDSCAPING REQUIREMENTS:

ALL PARKING SPACES SHALL BE WITH 60 FT OF A TREE. SEE PLAN FOR COMPLIANCE.

ONE TREE AND 10 SHRUBS SHALL BE PLANTED AN AVERAGE OF EVERY 50 FT ALONG THE PERIMETER OF OFF STREET PARKING AREAS THAT DO NOT ABUT A BUILDING OR PUBLIC STREET.

PROVIDED: 6 TREES WITHIN 60' OF EACH PARKING SPACE, 48 SCREENING AND INTERIOR ISLAND SHRUBS

## PLANT SCHEDULE

SYMBOL	CODE	QTY	BOTANICAL / COMMON NAME	CAL.	HEIGHT
TREES					
	LI	3	Lagerstroemia indica x fauriei 'Sarah's Favorite' / Sarah's Favorite Crape Myrtle Mulit-Trunk	2" Cal.	8-10'
	NG	4	Nyssa sylvatica 'NSUHH' / Green Gable™ Tupelo	2" Cal.	10-12'
	PC	3	Pistacia chinensis / Chinese Pistache	2" Cal.	10-12'
£ + 3	QL	3	Quercus lyrata / Overcup Oak	2" Cal.	10-12'
200-6	QP	2	Quercus phellos / Willow Oak	2" Cal.	10-12'
•	UP	2	Ulmus parvifolia 'Allee' / Allee Chinese Elm	2" Cal.	10-12'
SYMBOL	CODE	QTY	BOTANICAL / COMMON NAME	SIZE	
SHRUBS					
	AR	54	Abelia x 'Rose Creek' / Rose Creek Abelia	18-24" ht	
$\hat{\bullet}$	IB	17	Ilex cornuta 'Burfordii Nana' / Dwarf Burford Holly	18-24" ht	
***	AC	32	Ilex cornuta 'Carissa' / Carissa Chinese Holly	24-30" ht	
( · )	LC	13	Loropetalum chinense 'Shang-white' / Emerald Snow® Loropetalum	24-30" ht	
$\odot$	LS	22	Loropetalum chinense 'Snow Panda' / Snow Panda Fringe Flower	24-30" ht	

\* PLANT COUNTS PROVIDED FOR CONVENIENCE ONLY AND MAY DIFFER FROM QUANTITY DEPICTED ON PLAN. CONTRACTOR WILL BE HELD TO THE STRICTER STANDARD.


# AMENDED SOIL DEPTH NOTES:

CONTRACTOR SHALL AMEND SOILS IN AREAS WITH TURF TO DEPTH OF 6"

CONTRACTOR SHALL AMEND SOILS IN LANDSCAPE BED AREAS TO DEPTH OF 12" CONTRACTOR SHALL AMEND SOILS IN LANDSCAPE BED AREAS AND AT TREES NOT IN LANDSCAPE BEDS TO DEPTH OF 18".


### EXISTING SOIL MODIFICATIONS (AMENDED SOILS):

- A. CONTRACTOR SHALL REMOVE ALL ROCK AND DEBRIS FROM PLANTED AREAS.
- B. CONTRACTOR SHALL REMOVE EXCESS SOIL.

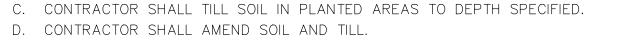




PLANTING PLAN MADISON PARK OUTPARCEL 2

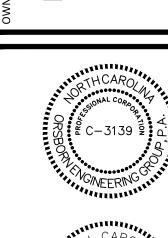



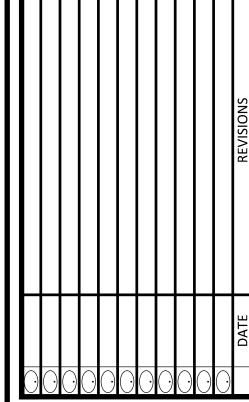



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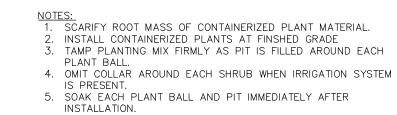
GRAPHIC SCALE


( IN FEET ) 1 inch = 20 ft.






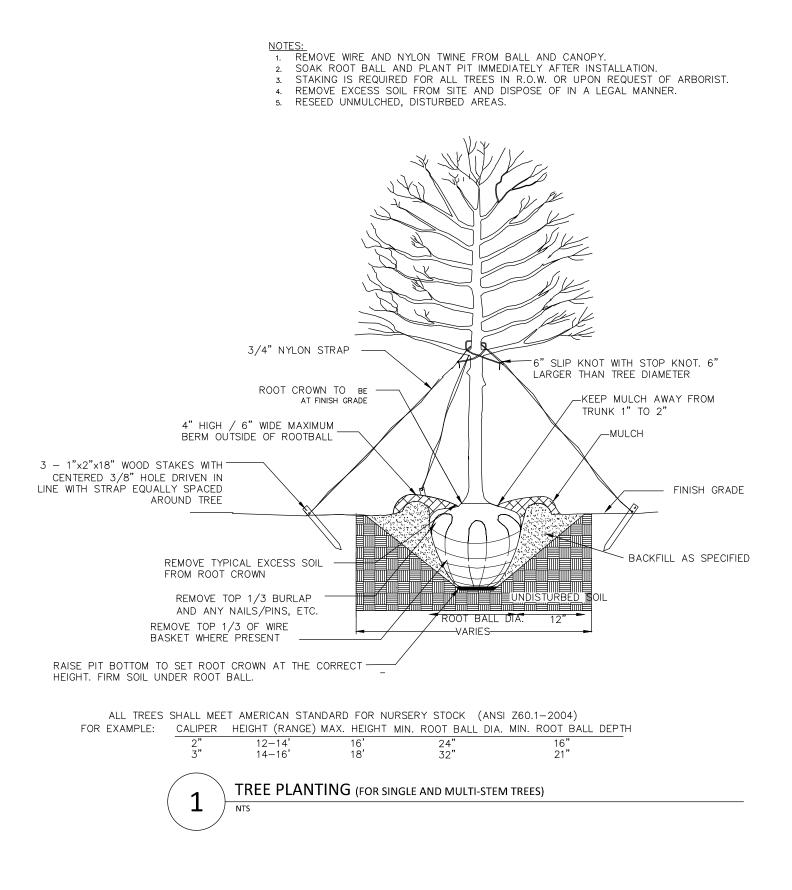

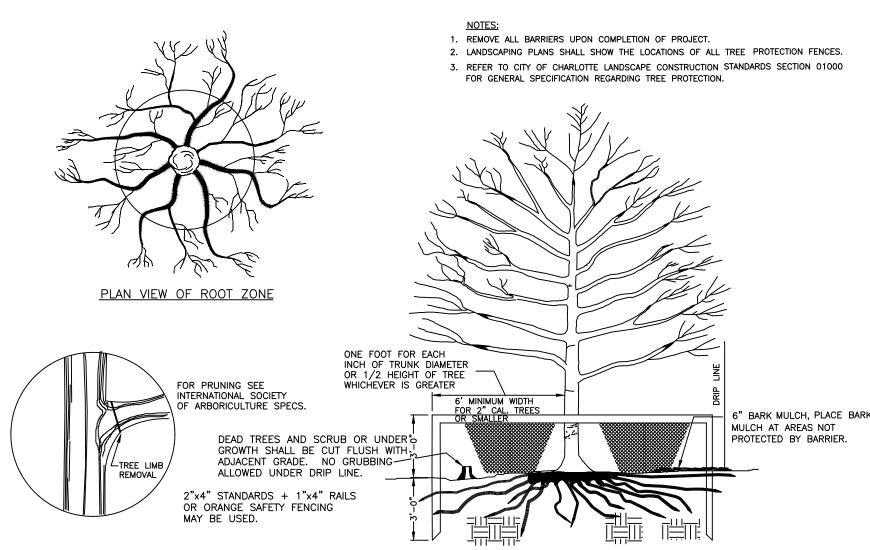


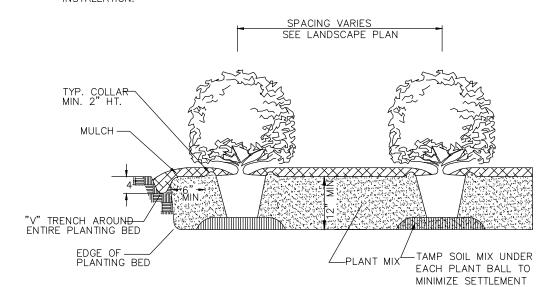

TYPICAL PLANTING BED DETAIL

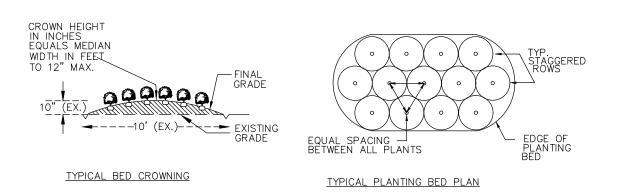

2 SHRUB PLANTING BED

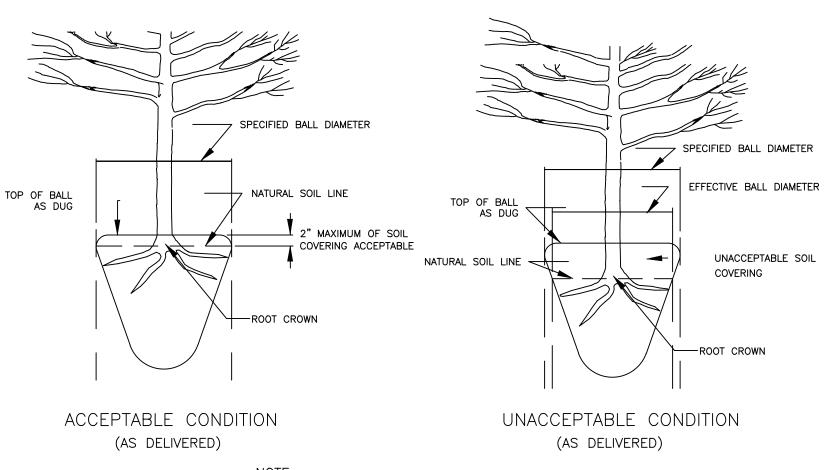

A ROOT COLLAR EXCAVATION FOR ALL TREES SPECIFIED WILL BE INSPECTED BY THE INSPECTOR TO ENSURE THAT TREES WERE NOT PLANTED/GROWN TOO DEEPLY AT SOURCE (NURSERY). LANDSCAPE CONTRACTOR SHALL HAVE SUPPLIER MARK GROUND LEVEL LINE ABOVE ROOT BALL. IF INSPECTOR DETERMINES THAT THERE IS EXCESSIVE SOIL OVER THE ROOT CROWN, THESE TREES WILL BE REJECTED.



IIS DOCUMENT, TOGETHER WITH THE CONCEPTS AND DESIGNS PRESENTED HEREIN, AS AN INSTRUMENT OF SERVICE, IS INTENDED ONLY FOR THE SPECIFIC PURPOSE AND CLIENT FOR WHICH IT WAS PREPARED. REUSE OF AND IMPROPER RELIANCE ON THIS DOCUMENT WITHOUT WRITTEN AUTHORIZATION AND ADAPTATION BY ORSBORN ENGINEERING GROUP, PA.

#### GENERAL LANDSCAPE NOTES

- 1. LANDSCAPE WORK SHALL BE COMPLETED BY A QUALIFIED CONTRACTOR TO THE TOWN OF WAXHAW SPECIFICATIONS AND AMERICAN STANDARD FOR NURSERY STOCK, LATEST EDITION, AMERICAN ASSOCIATION OF NURSERYMEN.
- 2. PRIOR TO BEGINNING WORK, LANDSCAPE CONTRACTOR SHALL FAMILIARIZE HIMSELF WITH THE SITE AND PERFORM SOIL TESTS IN EACH PLANTING AREA. PERFORM A MINIMUM OF 2 SOIL TESTS IN EACH GENERAL
- 3. MIX SOIL AMENDMENTS AND FERTILIZERS WITH EXISTING SOIL IN ACCORDANCE WITH SOIL RECOMMENDATIONS FOR PLANT TYPE AND BASED ON SOIL TEST RESULTS.
- 4. FOR NEW PLANTING AREAS, REMOVE ALL PAVEMENT, GRAVEL SUB-BASE AND CONSTRUCTION DEBRIS. REMOVE COMPACTED SOIL AND ADD 6" NEW TOPSOIL-OR-UNCOMPACT AND AMEND THE TOP 12" OF EXISTING SOIL TO MEET TOPSOIL/PLANTING MIX STANDARDS. AMEND ENTIRE PLANTING BED OR A MINIMUM OF 300 SF FOR INDIVIDUAL TREES.
- 5. LARGE MATURING TREES MAY NOT BE PLANTED UNDER OVERHEAD DISTRIBUTION OR TRANSMISSION LINES. IF TREES CONFLICT WITH POWER LINES OR SIGNS, CONTACT ENGINEER TO RESOLVE BEFORE PLANTING.
- 6. IF REQUIRED, ADJUST TREE PLANTING LOCATIONS TO AVOID UNDERGROUND UTILITIES.
- 7. THE INITIAL 2/3 OF BACKFILL AROUND PLANTED MATERIAL SHALL BE TAMPED AND WATERED THOROUGHLY TO SETTLE THE SOIL. AFTER SOIL SETTLES, FILL REMAINING PIT. WATER AND SHAPE SURFACE SO THAT IT SLOPES TO DRAIN FROM TRUNK AND MATCHES GROUND AT EDGE OF PLANTING PIT.
- 8. MULCH ALL TREE PITS, SHRUBS, GROUND COVER, AND PERENNIAL BEDS WITH A 2" LAYER OF MULCH IMMEDIATELY AFTER PLANTING. ALL BED LINES SHALL BE CUT WITH A SMOOTH CONSISTENT EDGE TO A MINIMUM DEPTH OF 3 INCHES.
- 9. PLANTING MAY OCCUR AT TIMES WHEN WATER IS NOT AVAILABLE ON SITE. LANDSCAPE CONTRACTOR IS RESPONSIBLE FOR BRINGING ADEQUATE WATER TO THE SITE TO COMPLETE HIS WORK.
- 10. ALL PLANTING AREAS SHALL CONFORM TO FINISHED GRADES AFTER FULL SETTLEMENT HAS OCCURRED AND MULCH HAS BEEN APPLIED.

#### PLANTING MIX

- 1. PLANTING MIX MAY BE DEVELOPED BY AMENDING THE EXISTING SOIL OR REMOVING THE EXISTING SOIL AND REPLACING WITH NEW PLANTING MIX. IT SHALL BE UNIFORM COMPOSITION THROUGHOUT, WITH A MIXTURE OF SUBSOIL. IT SHALL BE FREE OF STONES, LUMPS, LIVE PLANTS AND THEIR ROOTS, STICKS, AND OTHER EXTRANEOUS MATTER. IT SHALL CONTAIN NO MAN—MADE MATERIALS UNLESS OTHERWISE SPECIFIED. PLANTING MIX SHALL NOT BE USED WHILE IN A FROZEN OR MUDDY CONDITION. UNLESS OTHERWISE SPECIFIED IN THE CONTRACT
- 2. DOCUMENT THE PLANTING MIX SHALL CONTAIN THE FOLLOWING SPECIFIED PERCENTAGES OF CONSTITUENTS:

CLAY MINIMUM 10% - MAXIMUM 40%

SAND MINIMUM 20% - MAXIMUM 50%

SILT MINIMUM 20% - MAXIMUM 50%

ORGANIC MATERIAL MINIMUM 5% - MAXIMUM 10%

- 3. ORGANIC MATERIAL IS DEFINED AS COMPOST/HUMUS SUCH AS SAWDUST OR LEAF MOLD THAT HAS COMPLETED THE DECOMPRESSION PROCESS. PERCENTAGE OF ORGANIC MATTER SHALL BE DETERMINED BY LOSS ON IGNITION, OF MOISTURE FREE SAMPLES DRIED AT 65 DEGREES.
- 4. PLANTING MIX SHALL HAVE AN ACIDITY RANGE OF PH 5.5 TO 7.0.

#### SEEDING SCHEDULE

#### GENERAL NOTES

- 1. GROUND COVER PROTECTIVE COVER MUST BE ESTABLISHED ON ALL DISTURBED AREAS WITHIN 21 CALENDAR DAYS AFTER AND DISTURBING ACTIVITY IS COMPLETED OR HAS TEMPORARILY CEASED.
- 2. GRADED SLOPES AND FILLS PROTECTIVE COVER MUST BE ESTABLISHED ON ALL GRADED SLOPES AND FILLS WITHIN 21 CALENDAR DAYS AFTER AND DISTURBING ACTIVITY IS COMPLETED OR HAS TEMPORARILY CEASED.

#### SEEDBED PREPARATION

- 1. INSTALL NECESSARY MECHANICAL EROSION AND SEDIMENTATION CONTROL PRACTICES BEFORE SEEDING, AND COMPLETE GRADING ACCORDING TO THE APPROVED PLAN.
- 2. SPREAD TOPSOIL AT A DEPTH OF 4". WORK TOPSOIL INTO TOP 1-3" OF SUBGRADE (TOTAL PREPARED DEPTH = 4-6") BREAKING UP LARGE CLODS AND RAKING INTO A SMOOTH, UNIFORM SURFACE (SLOPES LESS THAN 3:1). LOOSE ROCKS, ROOTS, AND OTHER OBSTRUCTIONS SHALL BE REMOVED FROM THE SURFACE SO THAT THEY WILL NOT INTERFERE WITH THE ESTABLISHMENT AND MAINTENANCE OF VEGETATION. FILL IN OR LEVEL DEPRESSIONS THAT CAN COLLECT WATER.
- 3. IF REQUIRED, APPLY LIME AND FERTILIZER EVENLY AND INCORPORATE INTO THE TOP 4—6 INCHES OF SOIL BY DISKING OR OTHER SUITABLE
  MEANS. OPERATE MACHINERY ON THE CONTOUR. WHEN USING A HYDROSEEDER, APPLY LIME AND FERTILIZER TO A ROUGH, LOOSE SURFACE
- 4. BROADCAST SEED INTO A FRESHLY LOOSENED SEEDBED THAT HAS NOT BEEN SEALED BY RAINFALL. SURFACE FOR FINAL SEEDBED PREPARATION SHALL BE AT FINAL GRADES SHOWN.
- 5. LIME AND FERTILIZER NEEDS SHOULD BE DETERMINED BY SOIL TESTS. SOIL TESTING IS PERFORMED FREE OF CHARGE BY THE NORTH CAROLINA DEPARTMENT OF AGRICULTURE SOIL TESTING LABORATORY. DIRECTIONS, SAMPLE CARTONS, AND INFORMATION SHEETS ARE AVAILABLE THROUGH COUNTY AGRICULTURAL EXTENSION OFFICES OR FROM NCDA. BECAUSE THE NCDA SOIL TESTING LAB REQUIRES 1—6 WEEKS FOR SAMPLE TURN—AROUND, SAMPLING MUST BE PLANNED WELL IN ADVANCE OF FINAL GRADING. TESTING IS ALSO DONE BY
- 6. WHEN SOIL TESTS ARE NOT AVAILABLE, FOLLOW RATES SUGGESTED ON THE INDIVIDUAL SPECIFICATION SHEET FOR THE SEEDING MIX CHOSEN.
  APPLICATION RATES USUALLY FALL INTO THE FOLLOWING RANGES AS SHOWN BELOW..
- 7. CONTRACTOR SHALL ADJUST RATE OF APPLICATION FOR SEED, LIME, AND FERTILIZER TO MEET ACTUAL SITE CONDITIONS AND SOIL TESTS.

# SEEDING SCHEDULE CONT

# SEEDING RATES

MAY 1 - AUG. 15 --- 40 LBS/ACRE GERMAN MILLET AND 80 LBS/ACRE TALL FESCUE

APPLY LIME AND FERTILIZER PER SOIL TEST, OR 2000 LBS/ACRE LIMESTONE AND 750 LBS/ACRE 10-10-10 FERTILIZER.

REFERTILIZE IF GROWTH IS NOT FULLY ADEQUATE

REFERTILIZE IF GROWTH IS NOT FULLY ADEQUATE

APPLY 4000 LBS/ACRE STRAW OR EQUIVALENT HYDROSEEDING.

AUG. 25 - OCT. 15 -- GENTLE SLOPES 80 LBS/ACRE TA

80 LBS/ACRE TALL FESCUE STEEP SLOPES

100 LBS/ACRES TALL FESCUE AND 30 LBS/ACRE SERICEA LESPEDEZA (UNSCARIFIED AFTER AUG. 15)
10 LBS/ACRE KOBE LESPEDEZA

APPLY LIME AND FERTILIZER PER SOIL TESTS, OR 4000 LBS/ACRE LIMESTONE AND 1000 LBS/ACRE 10-10-10 FERTILIZER.

OVERSEEDING OF KOBE LESPEDEZA OVER FALL-SEEDED TALL FESCUE IS VERY EFFECTIVE.

OCT. 25 - DEC. 30 -- 120 LBS/ACRE RYE (GRAIN) AND 80 LBS/ACRE TALL FESCUE

APPLY LIME AND FERTILIZER PER SOIL TEST, OR 2000 LBS/ACRE LIMESTONE AND 750 LBS/ACRE 10-10-10 FERTILIZER.

BETWEEN DEC. 30 - FEB. 15, AD 50 LBS/ACRE OF ANNUAL KOBE LESPEDEZA.

APPLY 4000 LBS/ACRE STRAW OR EQUIVALENT HYDROSEEDING.

FEB. 15 — APR. 15 — GENTLE SLOPES

80 LBS /ACRE TALL FESC

80 LBS/ACRE TALL FESCUE STEEP SLOPES

100 LBS/ACRES TALL FESCUE AND 30 LBS/ACRE SERICEA LESPEDEZA (UNSCARIFIED AFTER AUG. 15)
10 LBS/ACRE KOBE LESPEDEZA

APPLY LIME AND FERTILIZER PER SOIL TESTS, OR 4000 LBS/ACRE LIMESTONE AND 1000 LBS/ACRE 10-10-10 FERTILIZER.

TO EXTEND SPRING SEEDING INTO JUNE, ADD 15 LBS/ACRE HULLED BERMUDAGRASS.

OVERSEEDING OF KOBE LESPEDEZA OVER FALL-SEEDED TALL FESCUE IS VERY EFFECTIVE.


ORSBORN
ENGINEERING GROUP
OS LEXINGTON AVENUE, SUITE 30

ISON PARK


DET

.C BLVD

MADISON WAXHA
OWNER, LLC
6805 MORRISON BLVI
CHARLOTTE NC 2821

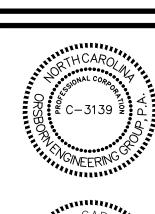



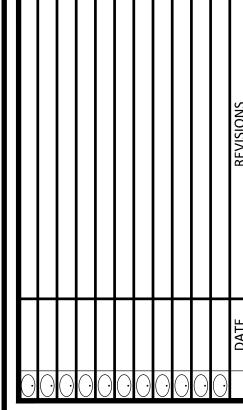

JOB#	23052
DATE:	04/01/24
SCALE:	1" = 20'
DRAWN BY:	LWL
APPROVED BY:	LWL

L1.2